

CITY OF LEEDS, ALABAMA

PLANNING AND ZONING COMMISSION AGENDA

Leeds Civic Center Meeting Room -1000 Park Drive, Leeds, Alabama 35094 **February 13, 2020** @ **5:00 PM**

CALL TO ORDER:
ROLL CALL:
DETERMINATION OF QUORUM:
APPROVAL OF MINUTES FROM PREVIOUS MEETING(S):
OLD BUSINESS:
NEW BUSINESS:
 SA20-000001: A request by Andrew and Lacey Barnwell, Applicant and Owner, to subdivide a parcel located at 1732 Whitmire St, Leeds, AL 35094, TPID 2500164012005000, Jefferson County, R-2 Single-Family. The proposed subdivision will consist of 2 lots.
SA20-000007 - FINAL PLAT - A request by AMAC Builders Group for final plat approval of the "Cottages at Lane" Subdivision located at 1916 Lane Dr, Leeds, AL 35094, TPID 2500162012008000, Jefferson County, zoned R-2, Single-Family District.
3. Election of Officers.
PUBLIC ADDRESS:
OTHER BUSINESS:
CHAIRPERSON'S COMMUNICATION:
ADJOURNMENT:
In compliance with the Americans with Disabilities Act, those requiring accommodation for Council meetings should notify the City Clerk's Office at least 24 hours prior to the meeting at 205-699-2585.

NOTICE OF PUBLIC HEARING

City of Leeds, Alabama Planning and Zoning Commission

> Application for Subdivision Resurvey of W.N. Lee Subdivision

APPLICATION

An application for a record subdivision plat approval has been filed with the City of Leeds Planning and Zoning Commission for "Resurvey of W.N. Lee Subdivision". This proposed subdivision consists of 2 lots and is zoned R-2, Single Family District.

PLANNING AND ZONING COMMISSION

The Planning and Zoning Commission is vested with the responsibility and authority of determining conformity with the City of Leeds Subdivision Regulations.

CASE #: SA20-000001

APPLICANT NAME: ANDREW AND LACEY BARNWELLL PROPERTY OWNER: ANDREW AND LACEY BARNWELLL

TAX PARCEL ID#s: 2500164012005000

CASE ADDRESS: 1732 WHITMIRE ST, LEEDS, AL 35094

JEFFERSON COUNTY

ZONED: R-2, SINGLE FMAILY DISTRICT

NOTICE IS HEREBY GIVEN that the Planning and Zoning Commission will hold a public hearing on the proposed RECORD plat. The hearing is scheduled on

Date: Thursday, February 13, 2020

Time: 5:00 p.m.

Place: Leeds Civic Center Meeting Room

1000 Park Drive Leeds, AL 35094

Public Information: Any interested persons or their representative may appear at the meeting and comment on the application. Written comments may also be mailed to the Commission.

For more information about the application and related issues or to schedule an appointment:

Phone: 205-699-0943

E-mail: development@leedsalabama.gov

Mailing Address:

City of Leeds Planning and Zoning Commission 1404 9th Street Leeds, AL 35094

REESER SURVEYING & MAPPING, LLC

15788 ALABAMA HIGHWAY #174
Pell City, Alabama 35125
Phone 205-338-2558
reesersurveying@gmail.com

SURV	EYOR	S CFF	RTIFIC	CATE

I, Darrell E. Reeser, the undersigned, do hereby certify that I am a Registered Land Surveyor in the State of Alabama, and that the RE-SURVEY OF LOT 5 BLOCK 2 OF W.N. LEE'S SURVEY, consisting of one sheet correctly represents a survey made under my supervision on the 30th day of dECEMBER, 2019; that all monuments shown heron actually exist; that the positions are accurately shown; that said plat shows the subdivisions into which it is proposed to divide said lands, giving the bearings and lengths of said boundaries at said lot and its number and shows the relation of the lands to the Government Survey of Section 16, Township 17 South, Range 1 East, Jefferson County, Alabama; that iron pins have been installed at all lot corners and curve points as shown and designated by small open circles on said plat or map; and that all parts of this survey and drawing have been completed in accordance with the requirements of the Standards for the Practice of Land Surveying in the State of Alabama to the best of my knowledge, information, and belief.

Darrell E. Reeser PLS No. 12158

STATE OF ALABAMA JEFFERSON COUNTY

STATE OF ALABAMA

JEFFERSON COUNTY

I, , a Notary P	ublic in and for said County and State do
hereby certify that Darrell E. Reeser, a Registered who is known to me, acknowledged before me on t	land Surveyor in the State of Alabama, and
contents of the said certificate, executed the same	voluntarily as an act of said Land Surveyor,
given under my hand and seal this the day o	of, 2020.

Notary Public
My commission expires _____

OWNER'S CERTIFICATE AND DEDICATION

I, the undersigned John Whitmere, do hereby certify that I am the owner of and the only person having any right, title, or interest in the land shown on the plat of RE-SURVEY OF LOT 5 BLOCK 2 OF W.N. LEE'S SURVEY, situated in the Southeast 1/4 of the Southeast 1/4 of Section 16, Township 17 South, Range 1 East, Jefferson County, and the plat represents a correct survey of the above described property made with my consent, and that I hereby dedicate to the public use all the streets as shown on said plat. The easements shown on said plat are created for the installation and maintenance of public utilities within and without this subdivision. I hereby guarantee a clear title to all lands so dedicated from myself and my heirs or assigns forever, and has caused the same to be released from all encumbrances so that the title is clear, except as shown in the Abstractor's Certificate.

WITNESS		hand, this the	day of	, 2020.
	John Whitmere			

I, ________, a Notary Public in and for said County and State do hereby certify that Darrell E. Reeser, a Registered land Surveyor in the State of Alabama, and who is known to me, acknowledged before me on this date after being duly informed of the contents of the said certificate, executed the same voluntarily as an act of said Land Surveyor, given under my hand and seal this the _____ day of _______, 2020.

Notary Public
My commission expires ______.

CITY OF LEEDS CERTIFICATE OF APPROVAL FOR RECORDING

I hereby certify that the subdivision plat for RE-SURVEY OF LOT 5 BLOCK 2 OF W.N. LEE'S SURVEY has been found to comply with the subdivision regulations for the City of Leeds, Alabama, with the exception of such variances, if any, are noted in the minutes of the Planning Commission; that it has been approved for recording in the Office of the Probate Judge of Jefferson County, Alabama, this the ______ day of ______, 2020.

Chairman of Planning Commission

CITY OF LEEDS, COUNCIL ACCEPTANCE OF PUBLIC DEDICATION

Be it Resolved by the City Council of the City of Leeds, Alabama, that the dedications shown on the attached plat of RE-SURVEY OF LOT 5 BLOCK 2 OF W.N. LEE'S SURVEY are hereby accepted.


Adopted by the City Council of the City of Leeds, this the _____ day of _____, 2020.

Mayor Date Clerk Date


ZONED R-4 SINGLE FAMILY RESIDENTIAL

FLOOD NOTE: By graphic plotting only, this property was found to be located within Flood Zone(s) X of the Flood Insurance Rate Map, Community Panel No. 01073C0441G

which bears an effective date of 9/29/2006 and is not in a Special Flood Hazard Area. No field surveying was performed to determine this zone and an elevation certificate may be needed to verify this determination or an application for a variance from the Federal Emergency Management Agency.

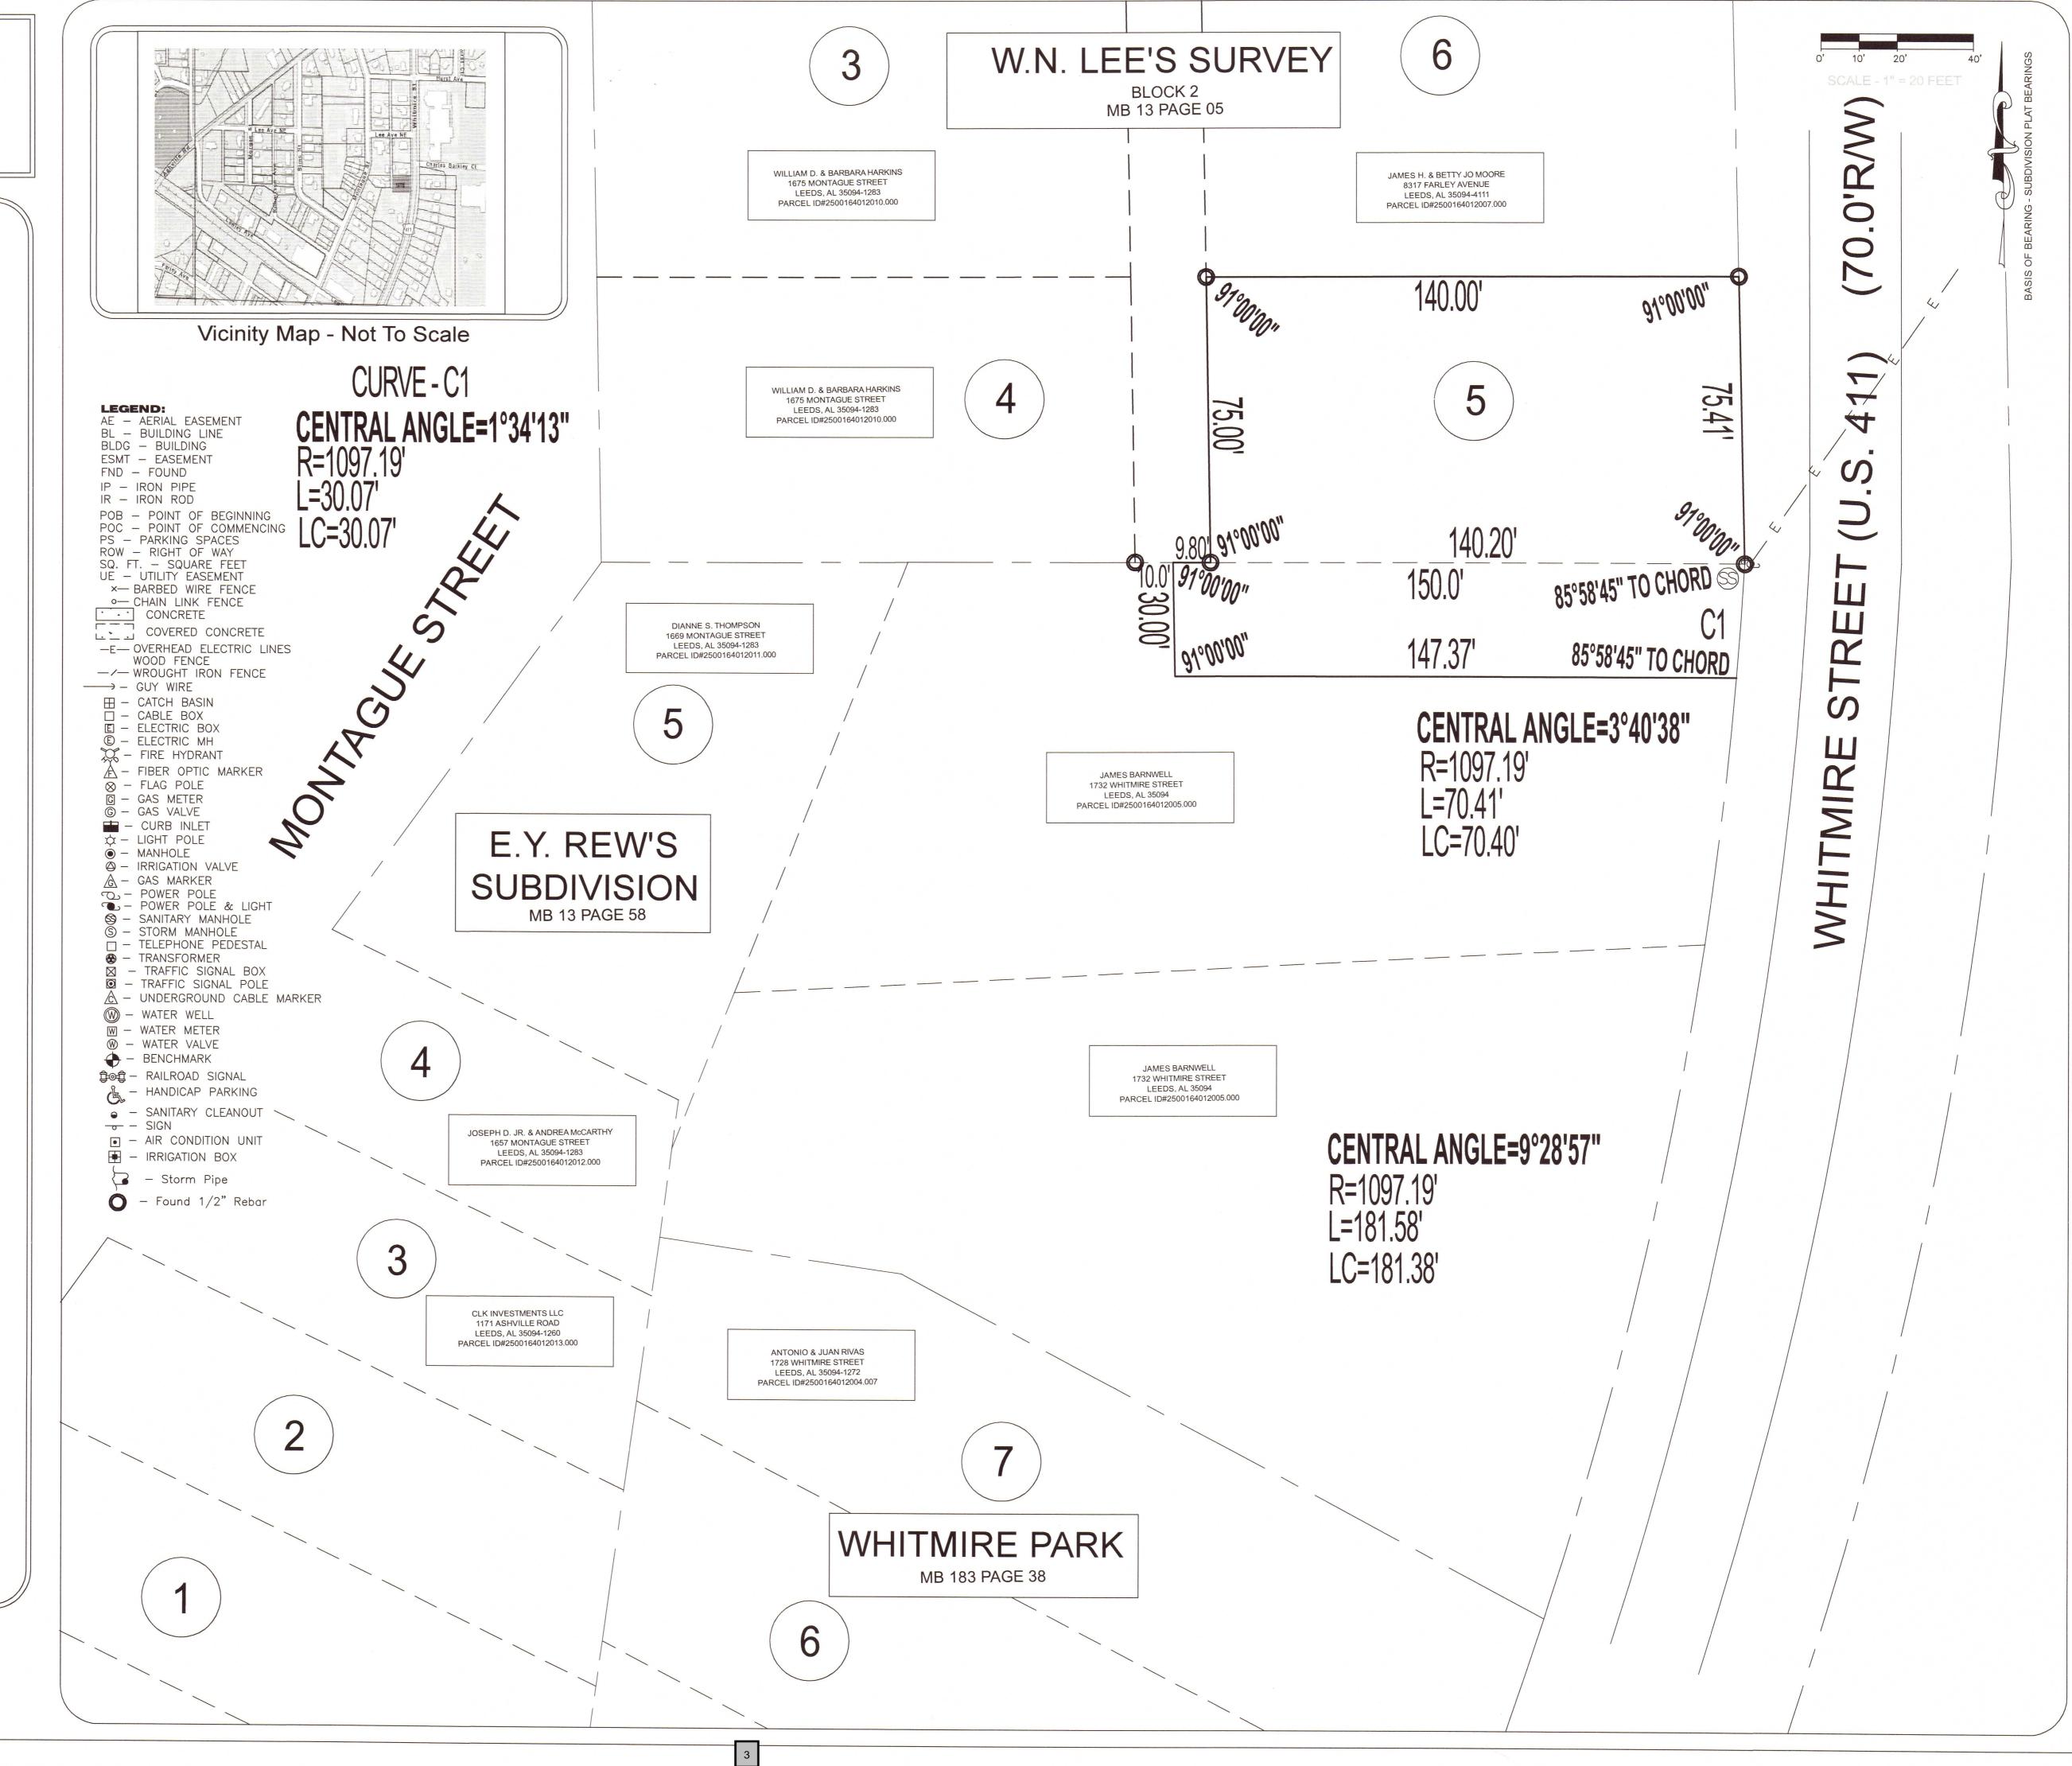


SA20-000001 AERIAL 2500164012005000 1732 WHITMIRE ST.

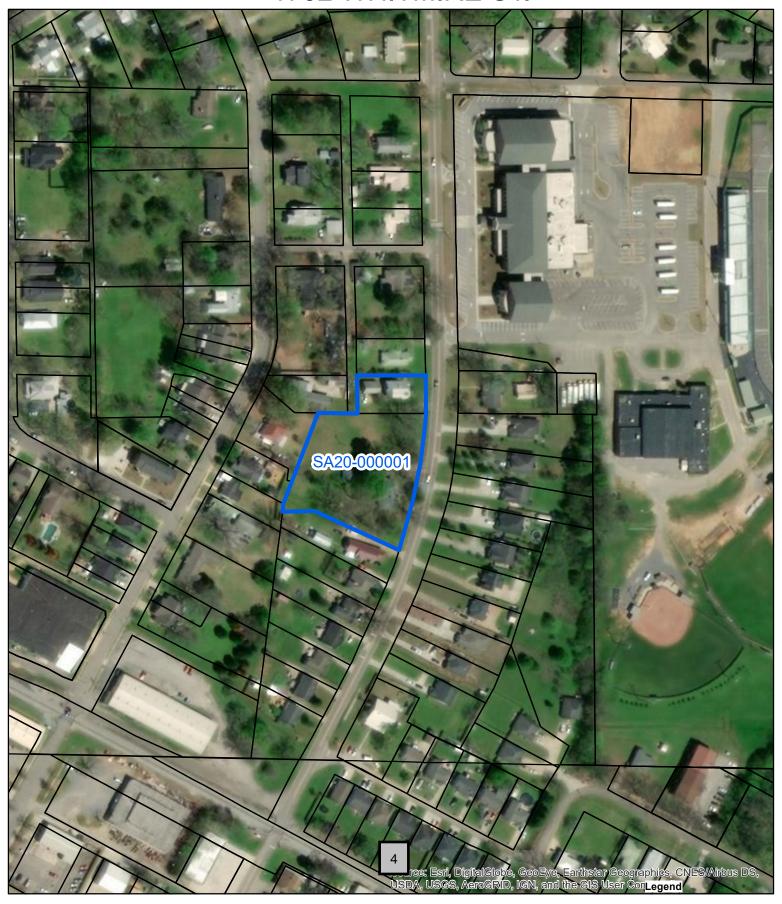

SA20-000001 STREET 2500164012005000 1732 WHITMIRE ST.




SA20-000001 ZONING 2500164012005000 1732 WHITMIRE ST.

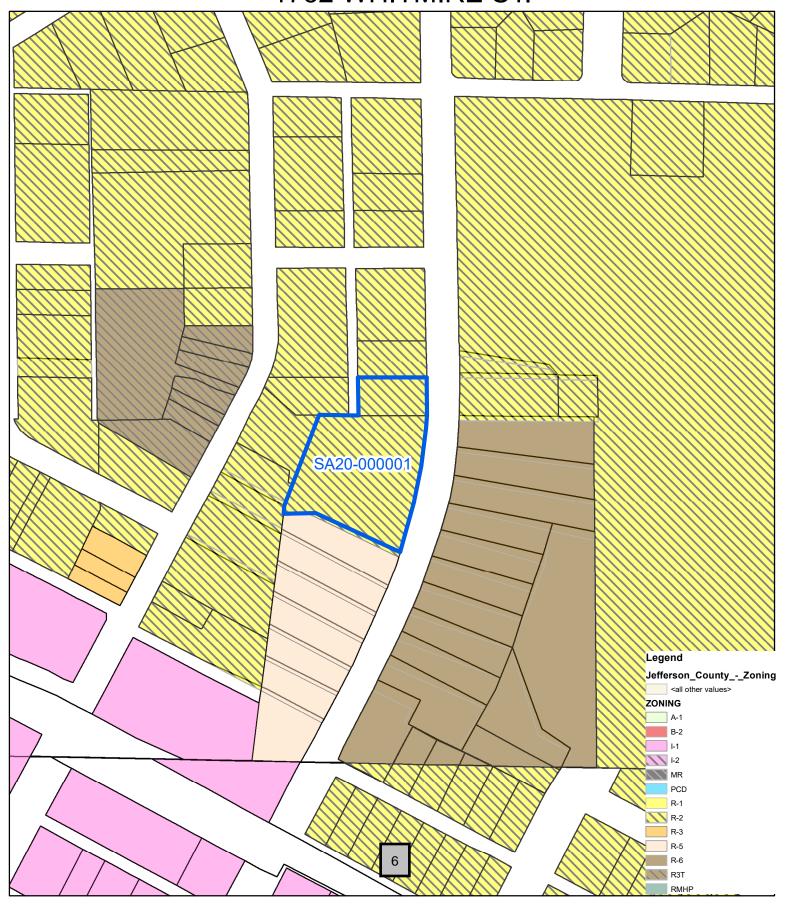


SA19-000007 1916 LANE DR 2500162012008000 AERIAL



SA19-000007 1916 LANE DR 2500162012008000 STREET

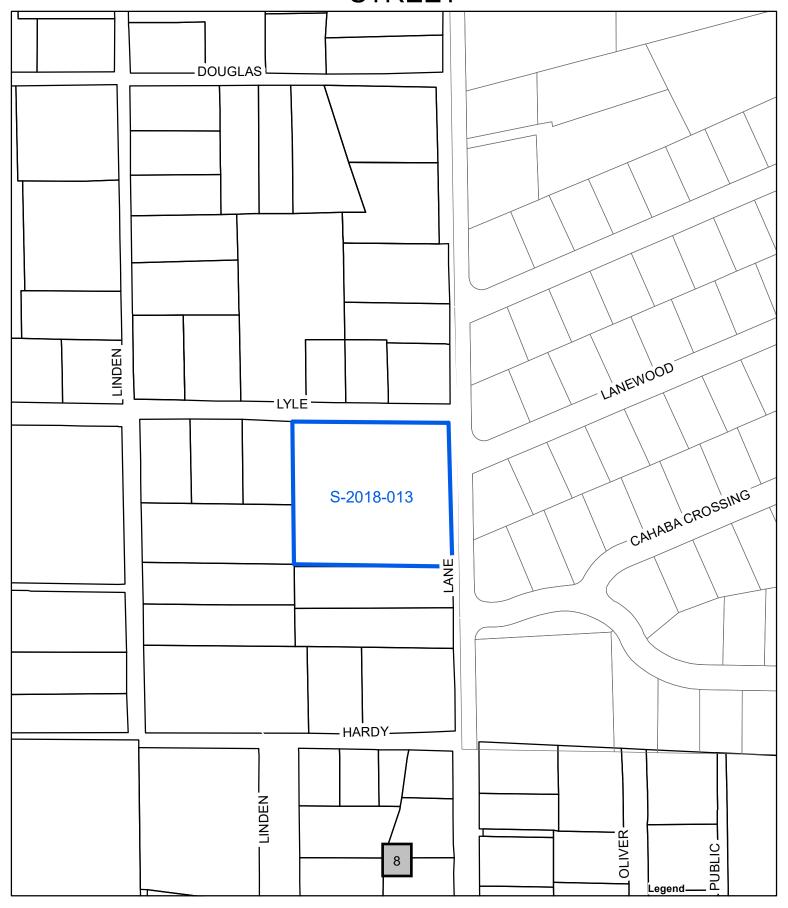

SA19-000007 1916 LANE DR 2500162012008000 ZONING

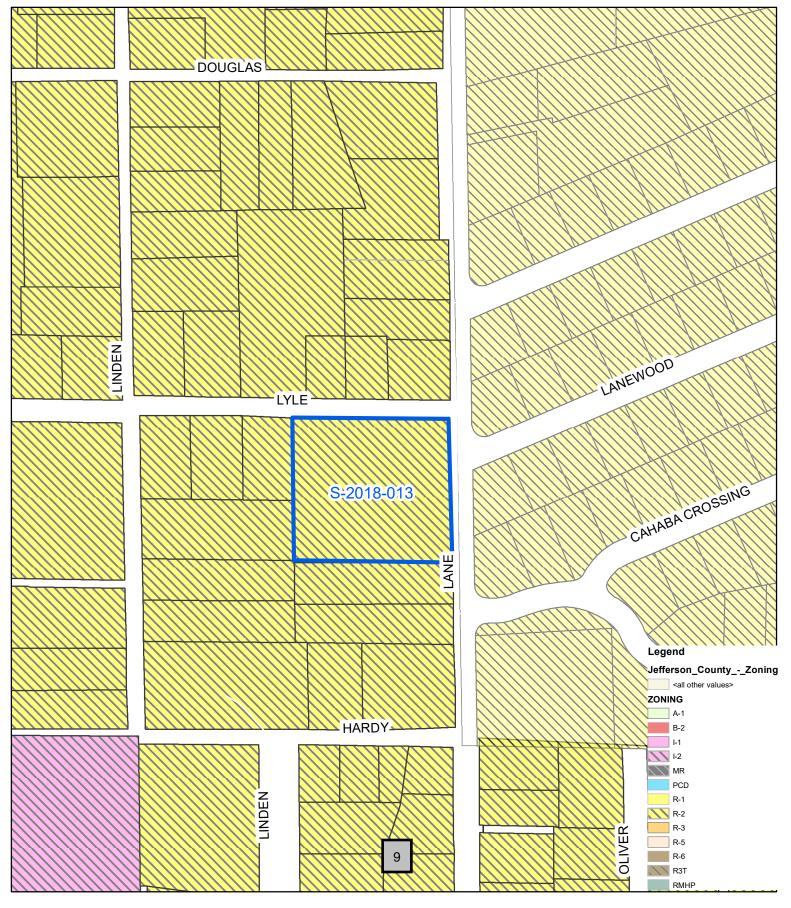

DRAWN: CHECKED: JAM III SCALE:

SHEET

Dozer treads create grooves perpendicular to the slope. TRACKING

SURFACE ROUGHENING OFF ROW ONLY

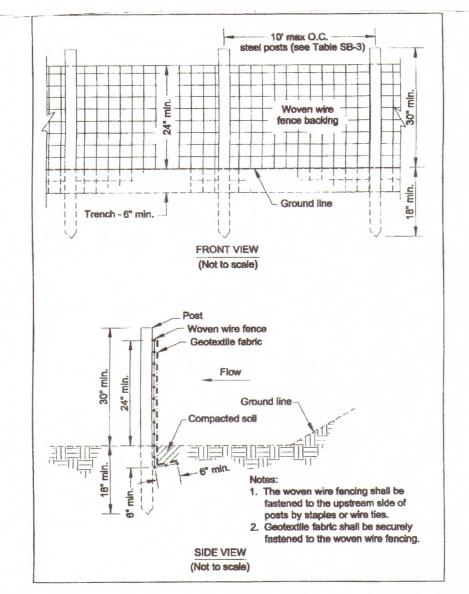


Figure SB-1 Silt Fence-Type A

(1) For fabric material requirements see Table SB-1
(2) For post material requirements see Tables SB-3 and SB-4

0 10 11	-
Specifications	Type A
Tensile Strength (Lbs. Min. ASTM D-46	Warp – 260 632) Fill – 100
Elongation (% Max (ASTM D-4632)	40
AOS (Apparent Opening (Max. Sieve Size) (ASTM	
Flow Rate (Gal/Min/Sq (GDT-87)	. Ft.) 70
Ultraviolet Stability (ASTM D-4632 after 300 weathering in accordance ASTM D-4355)	hours
Bursting Strength (PSI Min D-3786 Diaphragm Bur Strength Tester)	
Minimum Fabric Width (I	Inches) 36

1.3lb./ft. min.

Minimum roll average of 5 specimens
Percent of required initial minimum tensile strength. Table SB-3 Post Size for Silt Fence Size of Post Type of Post

Type A


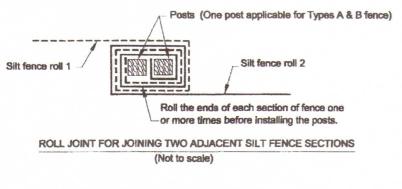


Figure SB-4 Silt Fence Installation Details

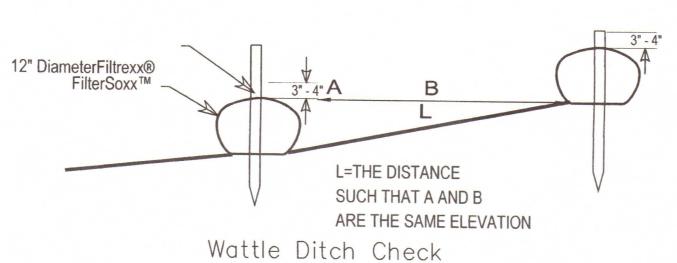

2"-3" STONE

Class II

Wattle Ditch Check

Stake on — 5' Lineal Spacing

GEOTEXTILE UNDERLINER-

CONSTRUCTION ENTRANCE

N. T. S.

GRASSED SWALE

Filtrexx® FilterSoxx™ or equal.

Stake on 5' Lineal

Spacing

Wattle Ditch Check Plan View



TEMPORARY AND PERMANENT SEEDING RATES

BERMUDA	APRIL 1 - JULY 1	USE 10 LBS PER ACRE
FESCUE, TALL	SEPT 1 - NOV 1	USE 40 - 50 LBS PER ACR
SERCEA	MARCH 15 - JULY 15	40 - 50 LBS PER ACRE
COMMON BERMUDA	MARCH 15 - JULY 15	10 LBS PER ACRE

Material Use 7	Mulching Materials and Rate Per Acre and (Per 1000 ft. ²)	Notes
Straw with	1 ½-2 tons (70 lbs-90 lbs)	Spread by hand or machine to attain 75% groundcover; anchor when subject to blowing.

Temporary Methods

Mulches

Mulch offers a fast, effective means of controlling dust when properly applied. See Mulching practice for guidelines for planning and installing the practice.

Temporary Vegetative Cover

For disturbed areas where no activity is anticipated for 14 days or longer, temporary seeding can effectively control dust. Establish vegetative cover according to Temporary Seeding practice guidelines.

Calcium Chloride

Calcium chloride may be applied by mechanical spreader as loose, dry granules or flakes at a rate that keeps the surface moist but not so high as to cause water pollution or plant damage. Sites may need to be retreated because the product degrades over time.

Sprinkling or Irrigation

Sprinkling is especially effective for dust control on haul roads and other traffic routes. Sprinkle the site until the surface is wet. Repeat as needed. Also bare areas may be kept wet with irrigation to control dust as an emergency treatment.


Tillage is used to roughen the site and bring clods and moist soil to the surface. This is a temporary emergency measure that can be used on large open disturbed areas as soon as soil blowing starts. Begin tilling on the windward edge of the site. The depth of tillage is determined by the depth to moist soil and the amount of moist soil desired at the surface. In sandy soils, the depth to moist soil may make tillage impractical.

Barriers


A board fence, wind fence, sediment fence, hay bales, or similar barriers can control air currents and blowing soil. Place barriers perpendicular to prevailing air currents at intervals about 15 times the barrier height.

10


ROCK HAMPTON Jan. 9th, 2019

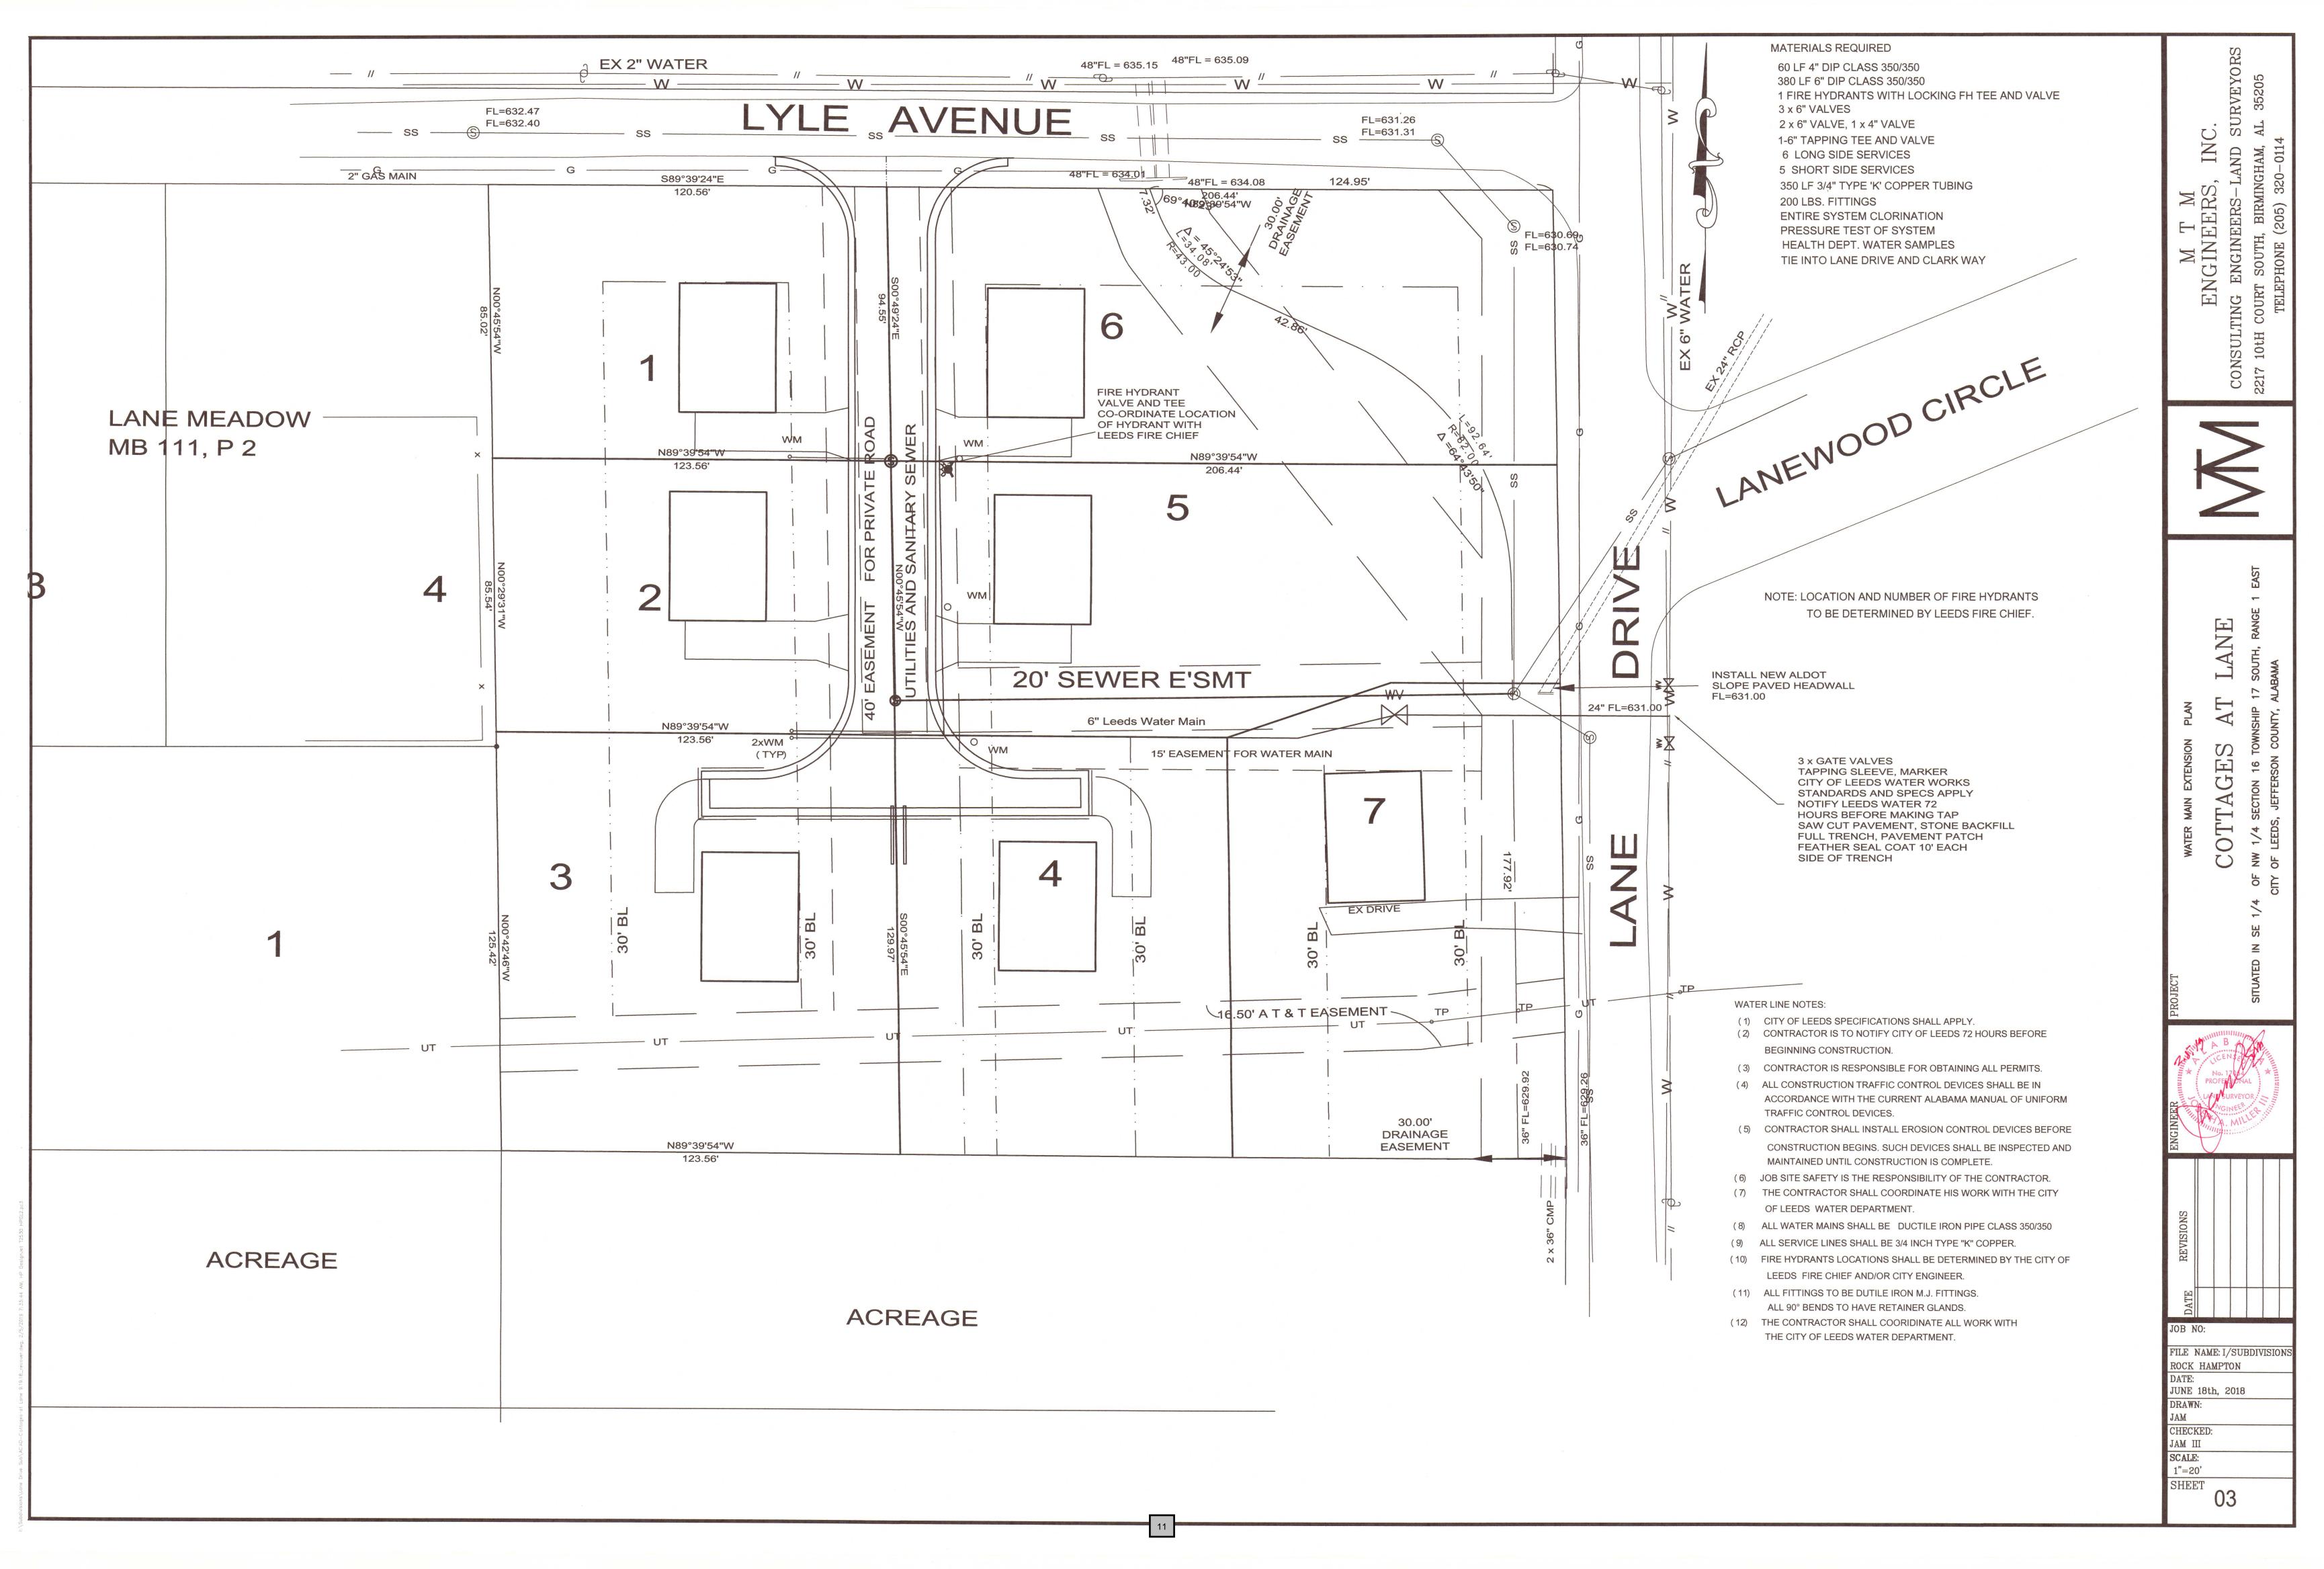

- 1. ALL TRAFFIC CONTROL DEVICES AND THEIR INSTALLATION SHALL BE IN ACCORDANCE WITH THE MOST CURRENT MANUAL ON UNIFORM TRAFFIC CONTROL DEVICES, LATEST EDITION, AND SHALL BE THE CONTRACTOR'S RESPONSIBILITY.
- 2. ALL CONTRUCTION SHALL BE IN ACCORDANCE WITH THE CITY LEEDS STANDARDS AND SPECIFICATIONS, LATEST EDITION.
- 3. NOTIFY CITY OF LEEDD 48 HOURS BEFORE BEGINNING CONSTRUCTION.
- 4. UTILITY LOCATIONS SHOWN ARE GRAPHICALLY PLOTTED FROM UTILITY COMPANY RECORDS AND ARE NOT FIELD VERIFIED. CONTRACTOR SHALL HAVE ALL UTILITIES FIELD LOCATED BEFORE BEGINNING CONSTRUCTION.
- 5. ALL ACTIVITIES SHALL BE CONDUCTED IN A LOGICAL SEQUENCE SO AS TO MINIMIZE THE AREA OF EXPOSED SOIL AT ONE TIME.
- 6. ANY SEDIMENT REACHING THE ROADWAY SHALL BE REMOVED BY STREET CLEANING, NOT BY FLUSHING, BEFORE THE END OF EACH DAY.
- 7. CONTRACTOR SHALL BE RESPONSIBLE FOR OBTAINING ALL REQUIRED PERMITS.
- 8. JOB SAFETY IS THE SOLE RESPONSIBLITY OF THE CONTRACTOR. 9. STONE BACKFILL SHALL BE USED THE FULL DEPTH OF TRENCH UNDER ALL PAVEMENT IN ROW ONLY.
- 10. SITE WILL SHEET FLOW
- 11. CONTRACTOR SHALL BE RESPONSIBLE FOR CONSTRUCTION & MAINTANCE OF EROSION AND SEDIMENTATION CONTROLS DURING CONSTRUCTION FOR PROTECTION OF ADJACENT PROPERTIES,
- ROADWAYS AND WATERWAYS.
- 12. CONTRACTOR AND DEVELOPER RESPONSIBLE FOR PROVIDING A BUILDING SITE FREE OF DRAINAGE PROBLEMS.
- 13. CONTRACTOR SHALL BE RESPONSIBLE FOR MAINTAINING A PROPER TRAFFIC CONTROL PLAN FOR PUBLIC SAFETY ADJACENT TO CONSTRUCTION SITE. THE TRAFFIC CONTROL PLAN SHALL BE IN ACCORDANCE WITH AMUTCD, LATEST EDITION.
- 14. ALL UTILITIES SHALL BE BACKFILLED WITH STONE.
- 15. NO SUBSURFACE INVESTIGATION HAS BEEN DONE BY MTM ENGINEERS, INC. A GEOTECHNICAL ENGINEER SHOULD REVIEW THE SITE BEFORE BEGINNING CONSTRUCTION.
- 16.ALL EXISTING UTILITIES APPURTENANCES, DRAINAGE STRUCTURES AND ACCESSORIES SHOULD BE DETERMINED TO MAINTAIN MINIMUM COVERAGE
- 17.ALL DISTURBED AREAS TO BE SEEDED OR SODDED PER LATEST AL DOT SPECIFICATIONS FOR GRASSING OR LANDSCAPED PER LANDSCAPE PLAN.
- 18. SANITARY SEWER SHALL MEET ALL STANDARDS AND SPECIFICATIONS OF JEFFERSON COUNTY ENVIRONMENTAL SERVICES

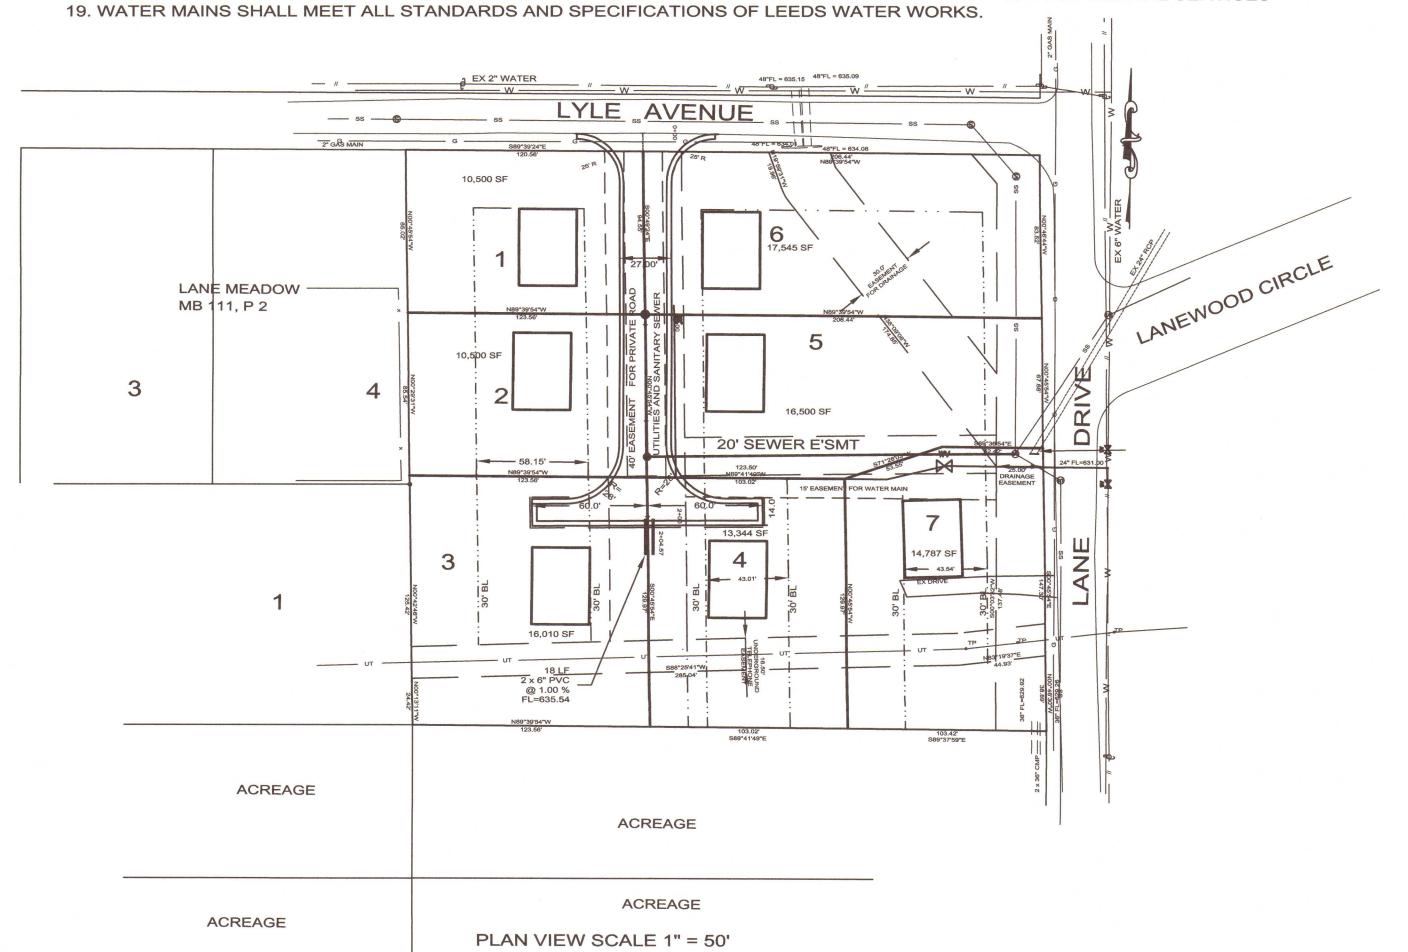

STREEET PROFILE

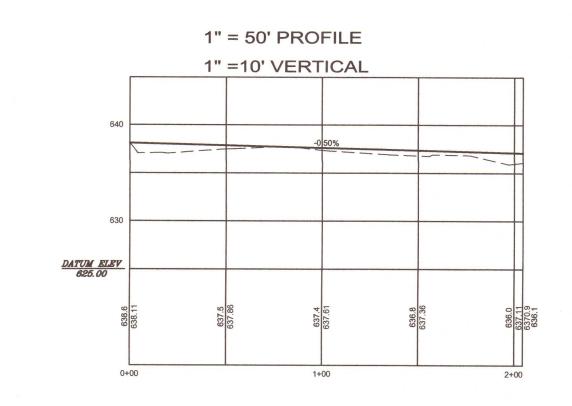

Z LA V 田 S S C COLL

FILE NAME: I/SUBDIVISIONS

LANE DRIVE JUNE 18th, 2018

CHECKED:

JAM III SCALE: 1"=50 PLAN, HOR. 1"=10 VERT

JOB NO: FILE NAME: I/SUBDIVISION

COTTAGES AT LANE JUNE 18th, 2018 DRAWN: CHECKED: JAM III SCALE: NTS

SHEET

FIRST ADDITION TO LEEDS & 184,2" 200 5 70' 75' 208" 209 2127 [a] ((6)209 718 (a) 196" 200'(a) 100" 109" 200'(a) 200.1" 109.8 85'(a) 2.1 100 LYLE AVENUE__ 100 100 100 1.2 SITE 100 100" 300 LANE MEADOW PR 111 PR 2 300" 335'(a) ALLEY 325% 300 3401 8 12 339.2" 330'(a) 110.0 195.2" 308.7 308.6" 110 HARDY AVENUE

VICINITY MAP (nts)

NOTES:

1. ALL TRAFFIC CONTROL DEVICES AND THEIR INSTALLATION SHALL BE IN ACCORDANCE WITH THE MOST CURRENT MANUAL ON UNIFORM TRAFFIC CONTROL DEVICES, LATEST EDITION, AND SHALL BE THE

DESCRIPTION

TITLE SHEET

PRELIMINARY PLAN

STANDARD DETAILS

EXSITING CONDITIONS

WATER MAIN EXTENSION

EROSION CONTROL DETAILS

STREET PLAN AND PROFILE

SANITARY SEWER DETAILS

EROSION SEDIMENT CONTROL PLAN

SANITARY SEWER PLAN AND PROFILE

SHEET

3

2. ALL CONTRUCTION SHALL BE IN ACCORDANCE WITH THE CITY LEEDS STANDARDS AND SPECIFICATIONS, LATEST EDITION. 3. NOTIFY CITY OF LEEDD 48 HOURS BEFORE BEGINNING CONSTRUCTION.

4. UTILITY LOCATIONS SHOWN ARE GRAPHICALLY PLOTTED FROM UTILITY COMPANY RECORDS AND ARE NOT FIELD VERIFIED. CONTRACTOR SHALL HAVE ALL UTILITIES FIELD LOCATED BEFORE BEGINNING

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16.ALL EXISTING UTILITIES APPURTENANCES, DRAINAGE STRUCTURES AND ACCESSORIES SHOULD BE DETERMINED TO MAINTAIN MINIMUM COVERAGE 17.ALL DISTURBED AREAS TO BE SEEDED OR SODDED PER LATEST AL DOT SPECIFICATIONS FOR GRASSING OR LANDSCAPED PER LANDSCAPE PLAN.

18. SANITARY SEWER SHALL MEET ALL STANDARDS AND SPECIFICATIONS OF JEFFERSON COUNTY ENVIRONMENTAL SERVICES

19. WATER MAINS SHALL MEET ALL STANDARDS AND SPECIFICATIONS OF LEEDS WATER WORKS.

- a. Site acreage = 2.3 acres b. smallest lot = 10,500 sf / 0.24 acres

No other findings

- d. 205 LF Private Street

B. There are no wooded areas, wetlands, unstable soils

C. Site Assement:

(d) bluffs - None

(c) colluvium - None

(e) sinkholes - None (f) caves - None

(h) lineaments - None

(I) springs - None

(I) wetlands - None

Wildlife Service - None

(q) spoils areas- None

adverse conditions affecting the site.

(a) geologic formations - None

E. Site Assement:

(c) colluvium - None (d) bluffs - None

(e) sinkholes - None

(h) lineaments - None (I) springs - None seeps - None

(I) wetlands - None

Wildlife Service - None

F. Site assessment map

for items a-t

G. Site Information

(q) spoils areas- None

(f) caves - None

() seeps - None

(a) geologic formations - None

(b) soils classifications - See Index at left

(g) landslides (active and inactive) - None

(m) Groundwater recharge points - None

approximate age of each community. =

(s) existing fills and excavations- None

(b) soils classifications - See Index at left

(g) landslides (active and inactive) - None

or slopes and any other adverse conditions affecting the site.

(k) streams (perennial, intermittent, wet weather) - None

(p) evidence of recent or ancient quarry operations - None

(k) streams (perennial, intermittent, wet weather) - None

(n) vegetative communities, including the five most abundant tree and

dump sites (active, inactive, or covered/reclaimed) - None

(u) wells, whether active or inactive, open or closed storage tanks,

regardless of contents, both above ground and underground-None

floral species for each community, in order of abundance and including the

(o) endangered and threatened species as determined by the US Fish and

(a) Joseph A. Miller, III, PE/LS 17054, Observed during site walk through

(b) Soils types by graphic plotting from Soils Conservation Service Map

(f) 25' Required front and 30' building setback lines for all Lots.

Groundwater recharge points - None

approximate age of each community. See table at right

(t) drainage retention and detention areas see plan

(c) Soils types shown on site assement ma

(d) There are no adverse effects from items a-u. (e) There are no adverse effects from items a-u.

(p) evidence of recent or ancient quarry operations - None

(r) dump sites (active, inactive, or covered/reclaimed) - None

(n) vegetative communities, including the five most abundant tree and

floral species for each community, in order of abundance and including the

(o) endangered and threatened species as determined by the US Fish and


D.There are no wooded areas, wetlands, unstable soils or slopes and any other


- c. 7 R-2 Lots
- 1. Fiber optic lines runs across southerly part of property, 16.5' easement

(b) Soils Classifications

9- Bodine-Fullerton association, steep Vegative communities covers entire site.

(n) Trees Pine Trees are most abundant species estimated 10, 20 to 40 years old Various species of hardwoods are next most abundant, estimated 5, 50-100 years old. No native flowers observed

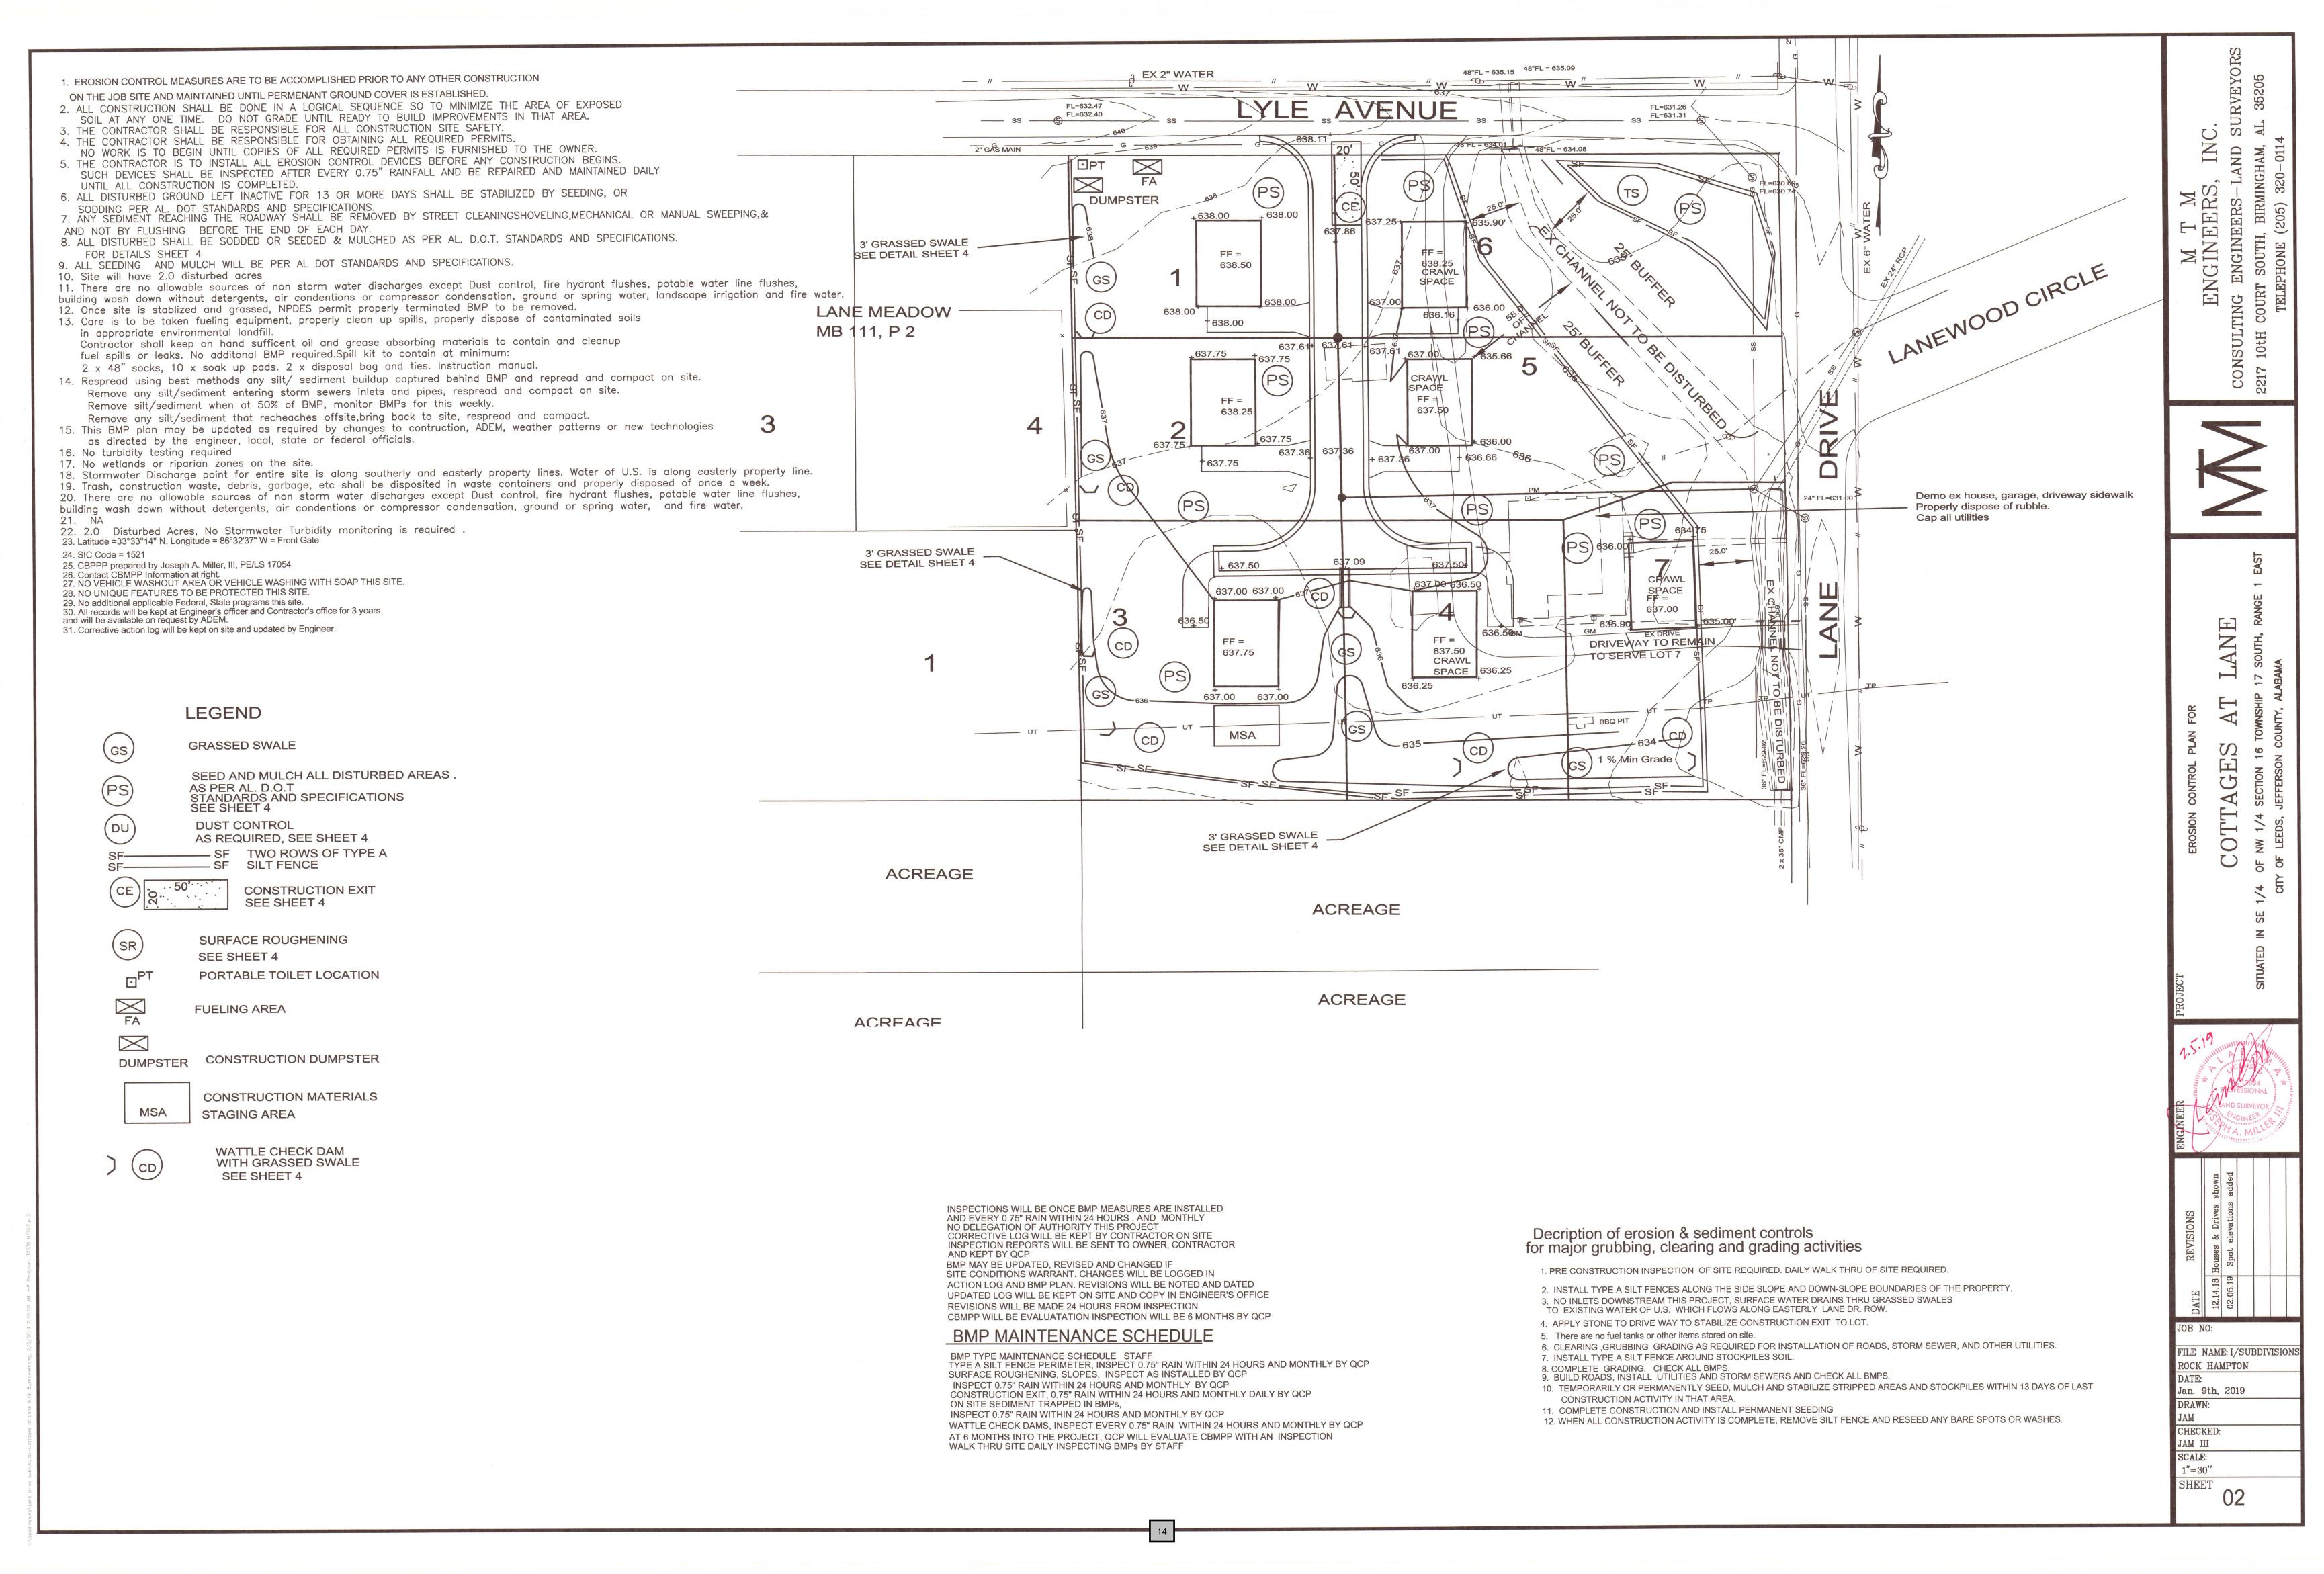

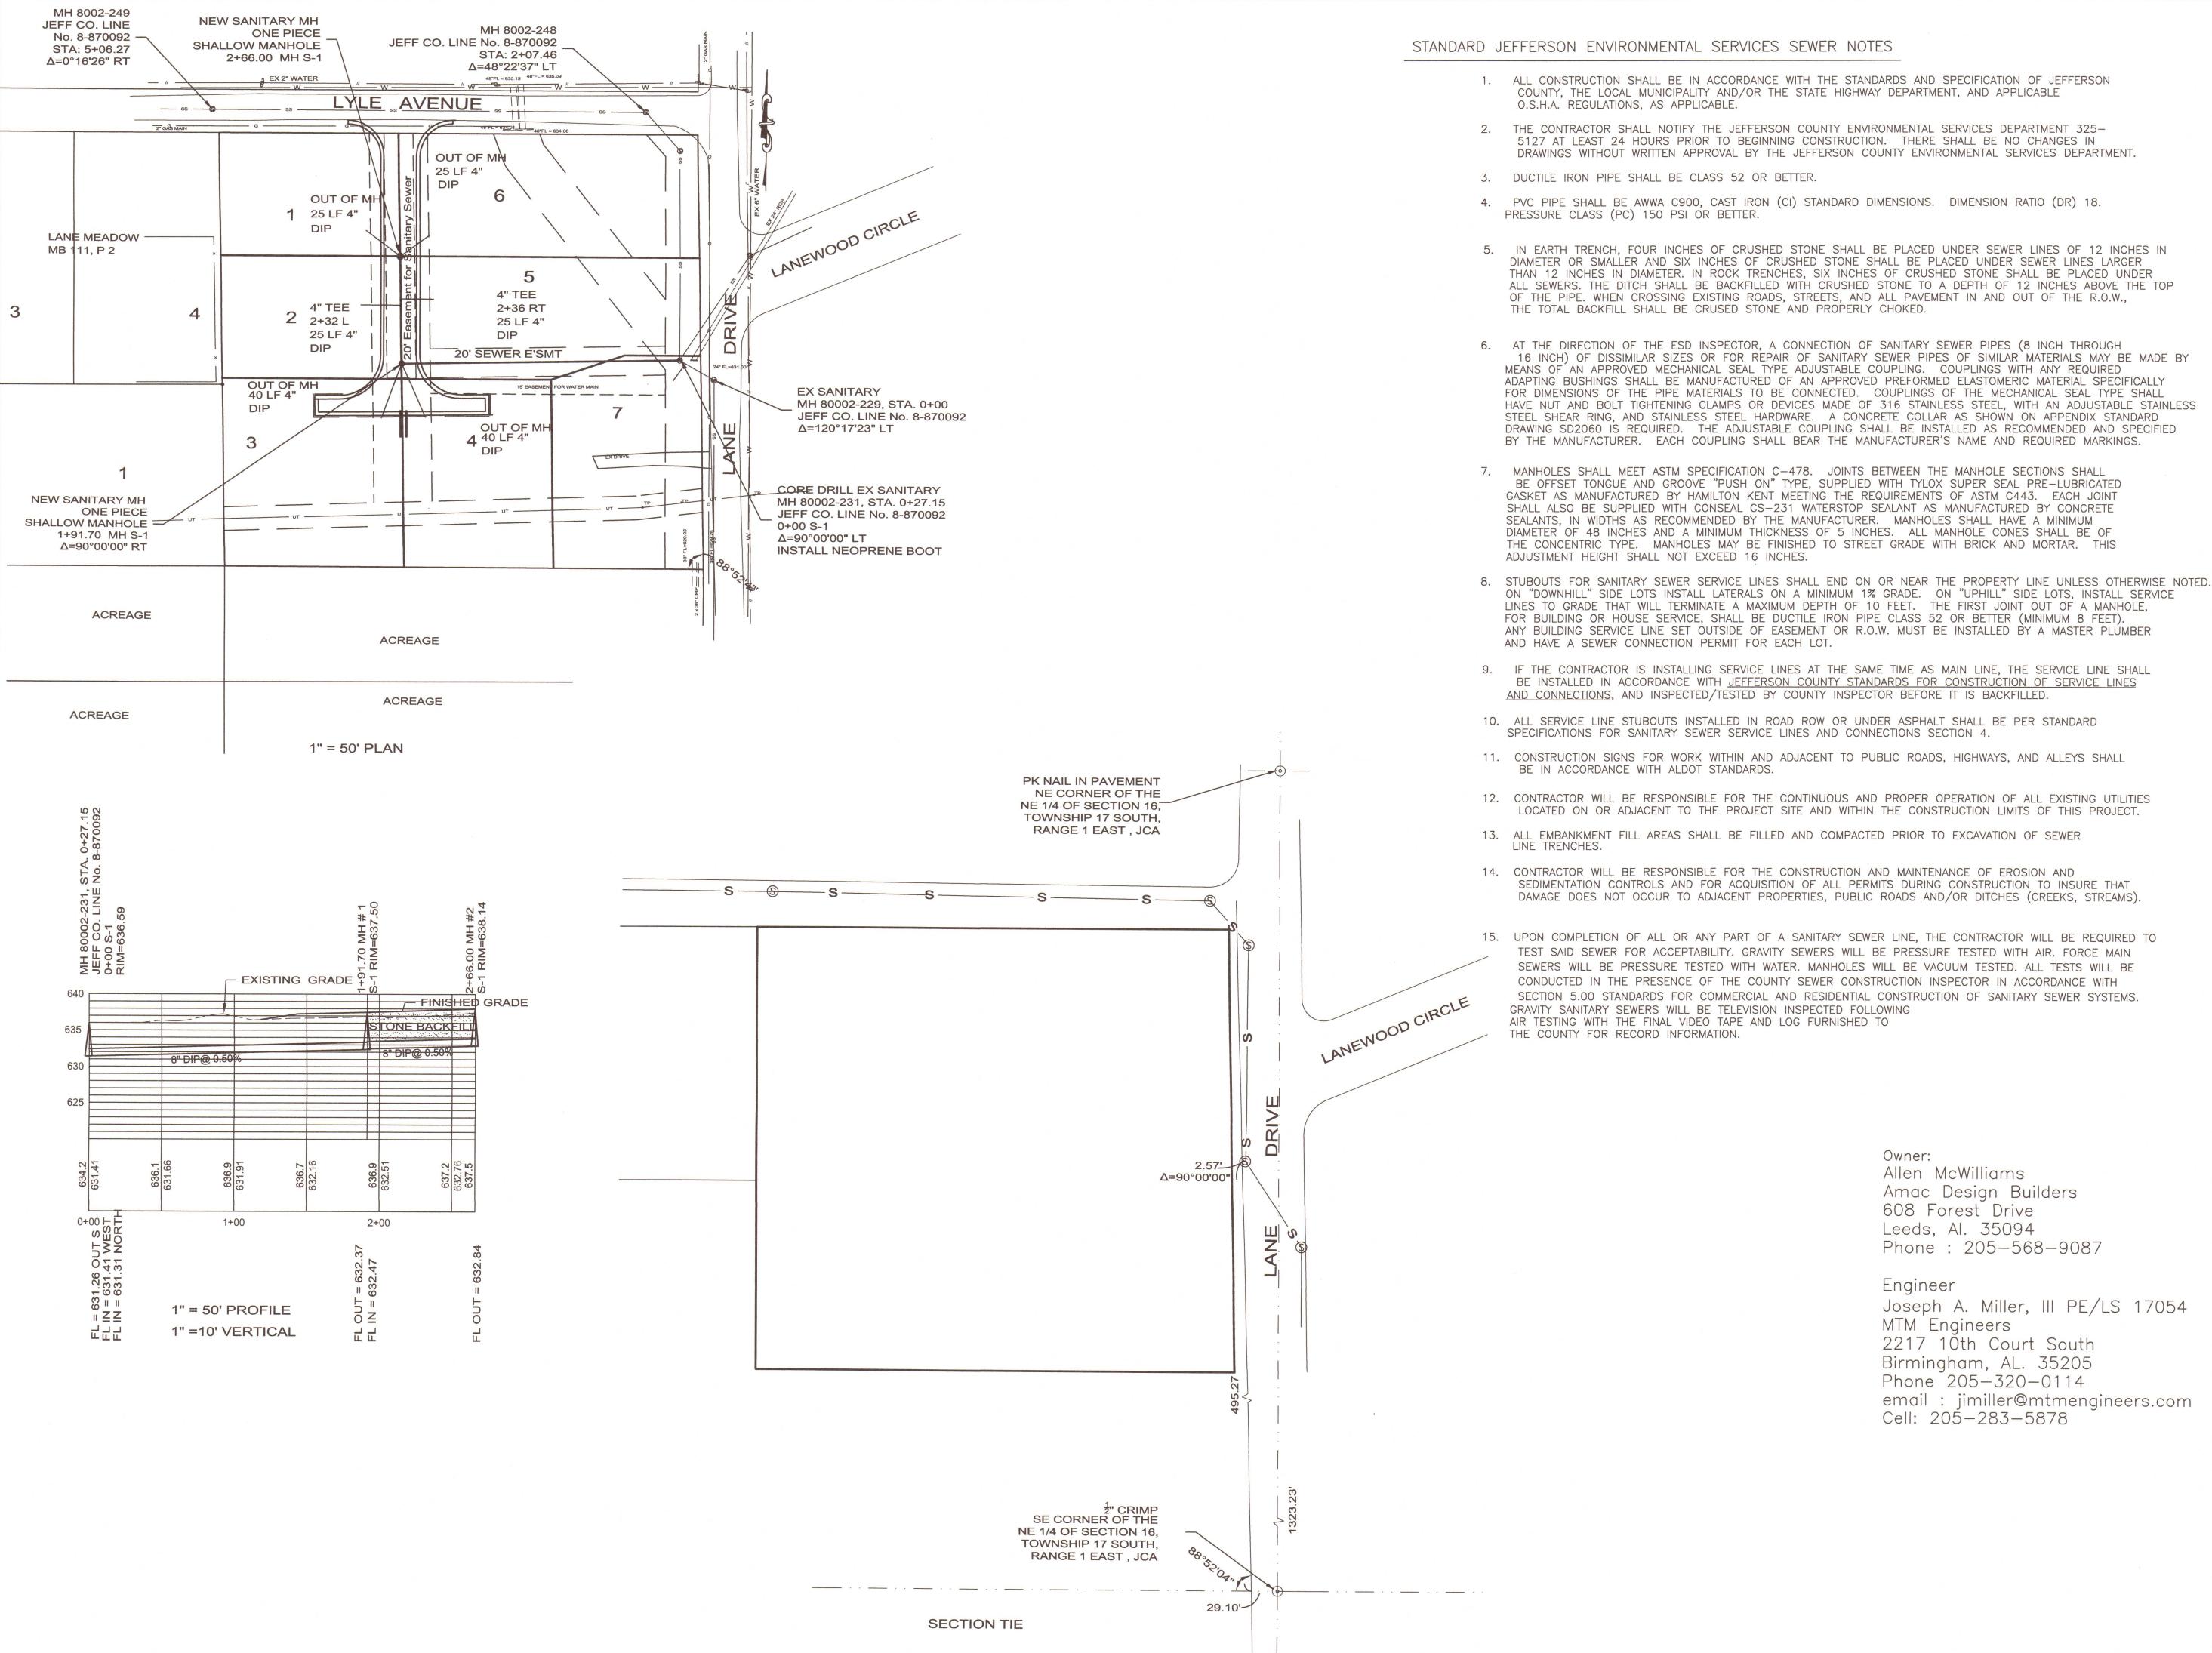

1. ALL CONSTRUCTION SHALL BE IN ACCORDANCE WITH THE STANDARDS AND SPECIFICATION OF JEFFERSON

- 2. THE CONTRACTOR SHALL NOTIFY THE JEFFERSON COUNTY ENVIRONMENTAL SERVICES DEPARTMENT 325-5127 AT LEAST 24 HOURS PRIOR TO BEGINNING CONSTRUCTION. THERE SHALL BE NO CHANGES IN DRAWINGS WITHOUT WRITTEN APPROVAL BY THE JEFFERSON COUNTY ENVIRONMENTAL SERVICES DEPARTMENT
- 4. PVC PIPE SHALL BE AWWA C900, CAST IRON (CI) STANDARD DIMENSIONS. DIMENSION RATIO (DR) 18.
- DIAMETER OR SMALLER AND SIX INCHES OF CRUSHED STONE SHALL BE PLACED UNDER SEWER LINES LARGER THAN 12 INCHES IN DIAMETER. IN ROCK TRENCHES, SIX INCHES OF CRUSHED STONE SHALL BE PLACED UNDER ALL SEWERS. THE DITCH SHALL BE BACKFILLED WITH CRUSHED STONE TO A DEPTH OF 12 INCHES ABOVE THE TOP OF THE PIPE. WHEN CROSSING EXISTING ROADS, STREETS, AND ALL PAVEMENT IN AND OUT OF THE R.O.W.,
- AT THE DIRECTION OF THE ESD INSPECTOR, A CONNECTION OF SANITARY SEWER PIPES (8 INCH THROUGH 16 INCH) OF DISSIMILAR SIZES OR FOR REPAIR OF SANITARY SEWER PIPES OF SIMILAR MATERIALS MAY BE MADE BY MEANS OF AN APPROVED MECHANICAL SEAL TYPE ADJUSTABLE COUPLING. COUPLINGS WITH ANY REQUIRED ADAPTING BUSHINGS SHALL BE MANUFACTURED OF AN APPROVED PREFORMED ELASTOMERIC MATERIAL SPECIFICALLY FOR DIMENSIONS OF THE PIPE MATERIALS TO BE CONNECTED. COUPLINGS OF THE MECHANICAL SEAL TYPE SHALL HAVE NUT AND BOLT TIGHTENING CLAMPS OR DEVICES MADE OF 316 STAINLESS STEEL, WITH AN ADJUSTABLE STAINLESS STEEL SHEAR RING, AND STAINLESS STEEL HARDWARE. A CONCRETE COLLAR AS SHOWN ON APPENDIX STANDARD DRAWING SD2060 IS REQUIRED. THE ADJUSTABLE COUPLING SHALL BE INSTALLED AS RECOMMENDED AND SPECIFIED
- BE OFFSET TONGUE AND GROOVE "PUSH ON" TYPE, SUPPLIED WITH TYLOX SUPER SEAL PRE-LUBRICATED GASKET AS MANUFACTURED BY HAMILTON KENT MEETING THE REQUIREMENTS OF ASTM C443. EACH JOINT SHALL ALSO BE SUPPLIED WITH CONSEAL CS-231 WATERSTOP SEALANT AS MANUFACTURED BY CONCRETE SEALANTS. IN WIDTHS AS RECOMMENDED BY THE MANUFACTURER. MANHOLES SHALL HAVE A MINIMUM DIAMETER OF 48 INCHES AND A MINIMUM THICKNESS OF 5 INCHES. ALL MANHOLE CONES SHALL BE OF THE CONCENTRIC TYPE. MANHOLES MAY BE FINISHED TO STREET GRADE WITH BRICK AND MORTAR. THIS
- ON "DOWNHILL" SIDE LOTS INSTALL LATERALS ON A MINIMUM 1% GRADE. ON "UPHILL" SIDE LOTS, INSTALL SERVICE LINES TO GRADE THAT WILL TERMINATE A MAXIMUM DEPTH OF 10 FEET. THE FIRST JOINT OUT OF A MANHOLE, FOR BUILDING OR HOUSE SERVICE, SHALL BE DUCTILE IRON PIPE CLASS 52 OR BETTER (MINIMUM 8 FEET). ANY BUILDING SERVICE LINE SET OUTSIDE OF EASEMENT OR R.O.W. MUST BE INSTALLED BY A MASTER PLUMBER
- IF THE CONTRACTOR IS INSTALLING SERVICE LINES AT THE SAME TIME AS MAIN LINE, THE SERVICE LINE SHALL BE INSTALLED IN ACCORDANCE WITH JEFFERSON COUNTY STANDARDS FOR CONSTRUCTION OF SERVICE LINES
- 11. CONSTRUCTION SIGNS FOR WORK WITHIN AND ADJACENT TO PUBLIC ROADS, HIGHWAYS, AND ALLEYS SHALL
- 12. CONTRACTOR WILL BE RESPONSIBLE FOR THE CONTINUOUS AND PROPER OPERATION OF ALL EXISTING UTILITIES LOCATED ON OR ADJACENT TO THE PROJECT SITE AND WITHIN THE CONSTRUCTION LIMITS OF THIS PROJECT.
- SEDIMENTATION CONTROLS AND FOR ACQUISITION OF ALL PERMITS DURING CONSTRUCTION TO INSURE THAT
- 15. UPON COMPLETION OF ALL OR ANY PART OF A SANITARY SEWER LINE, THE CONTRACTOR WILL BE REQUIRED TO TEST SAID SEWER FOR ACCEPTABILITY. GRAVITY SEWERS WILL BE PRESSURE TESTED WITH AIR. FORCE MAIN SEWERS WILL BE PRESSURE TESTED WITH WATER. MANHOLES WILL BE VACUUM TESTED. ALL TESTS WILL BE CONDUCTED IN THE PRESENCE OF THE COUNTY SEWER CONSTRUCTION INSPECTOR IN ACCORDANCE WITH SECTION 5.00 STANDARDS FOR COMMERCIAL AND RESIDENTIAL CONSTRUCTION OF SANITARY SEWER SYSTEMS.

Joseph A. Miller, III PE/LS 17054 email : jimiller@mtmengineers.com Cell: 205—283—5878

INC ERS-LAND BIRMINGHAM, M T M ENGINEERS,

CONSULTING 2217 10tH COUR


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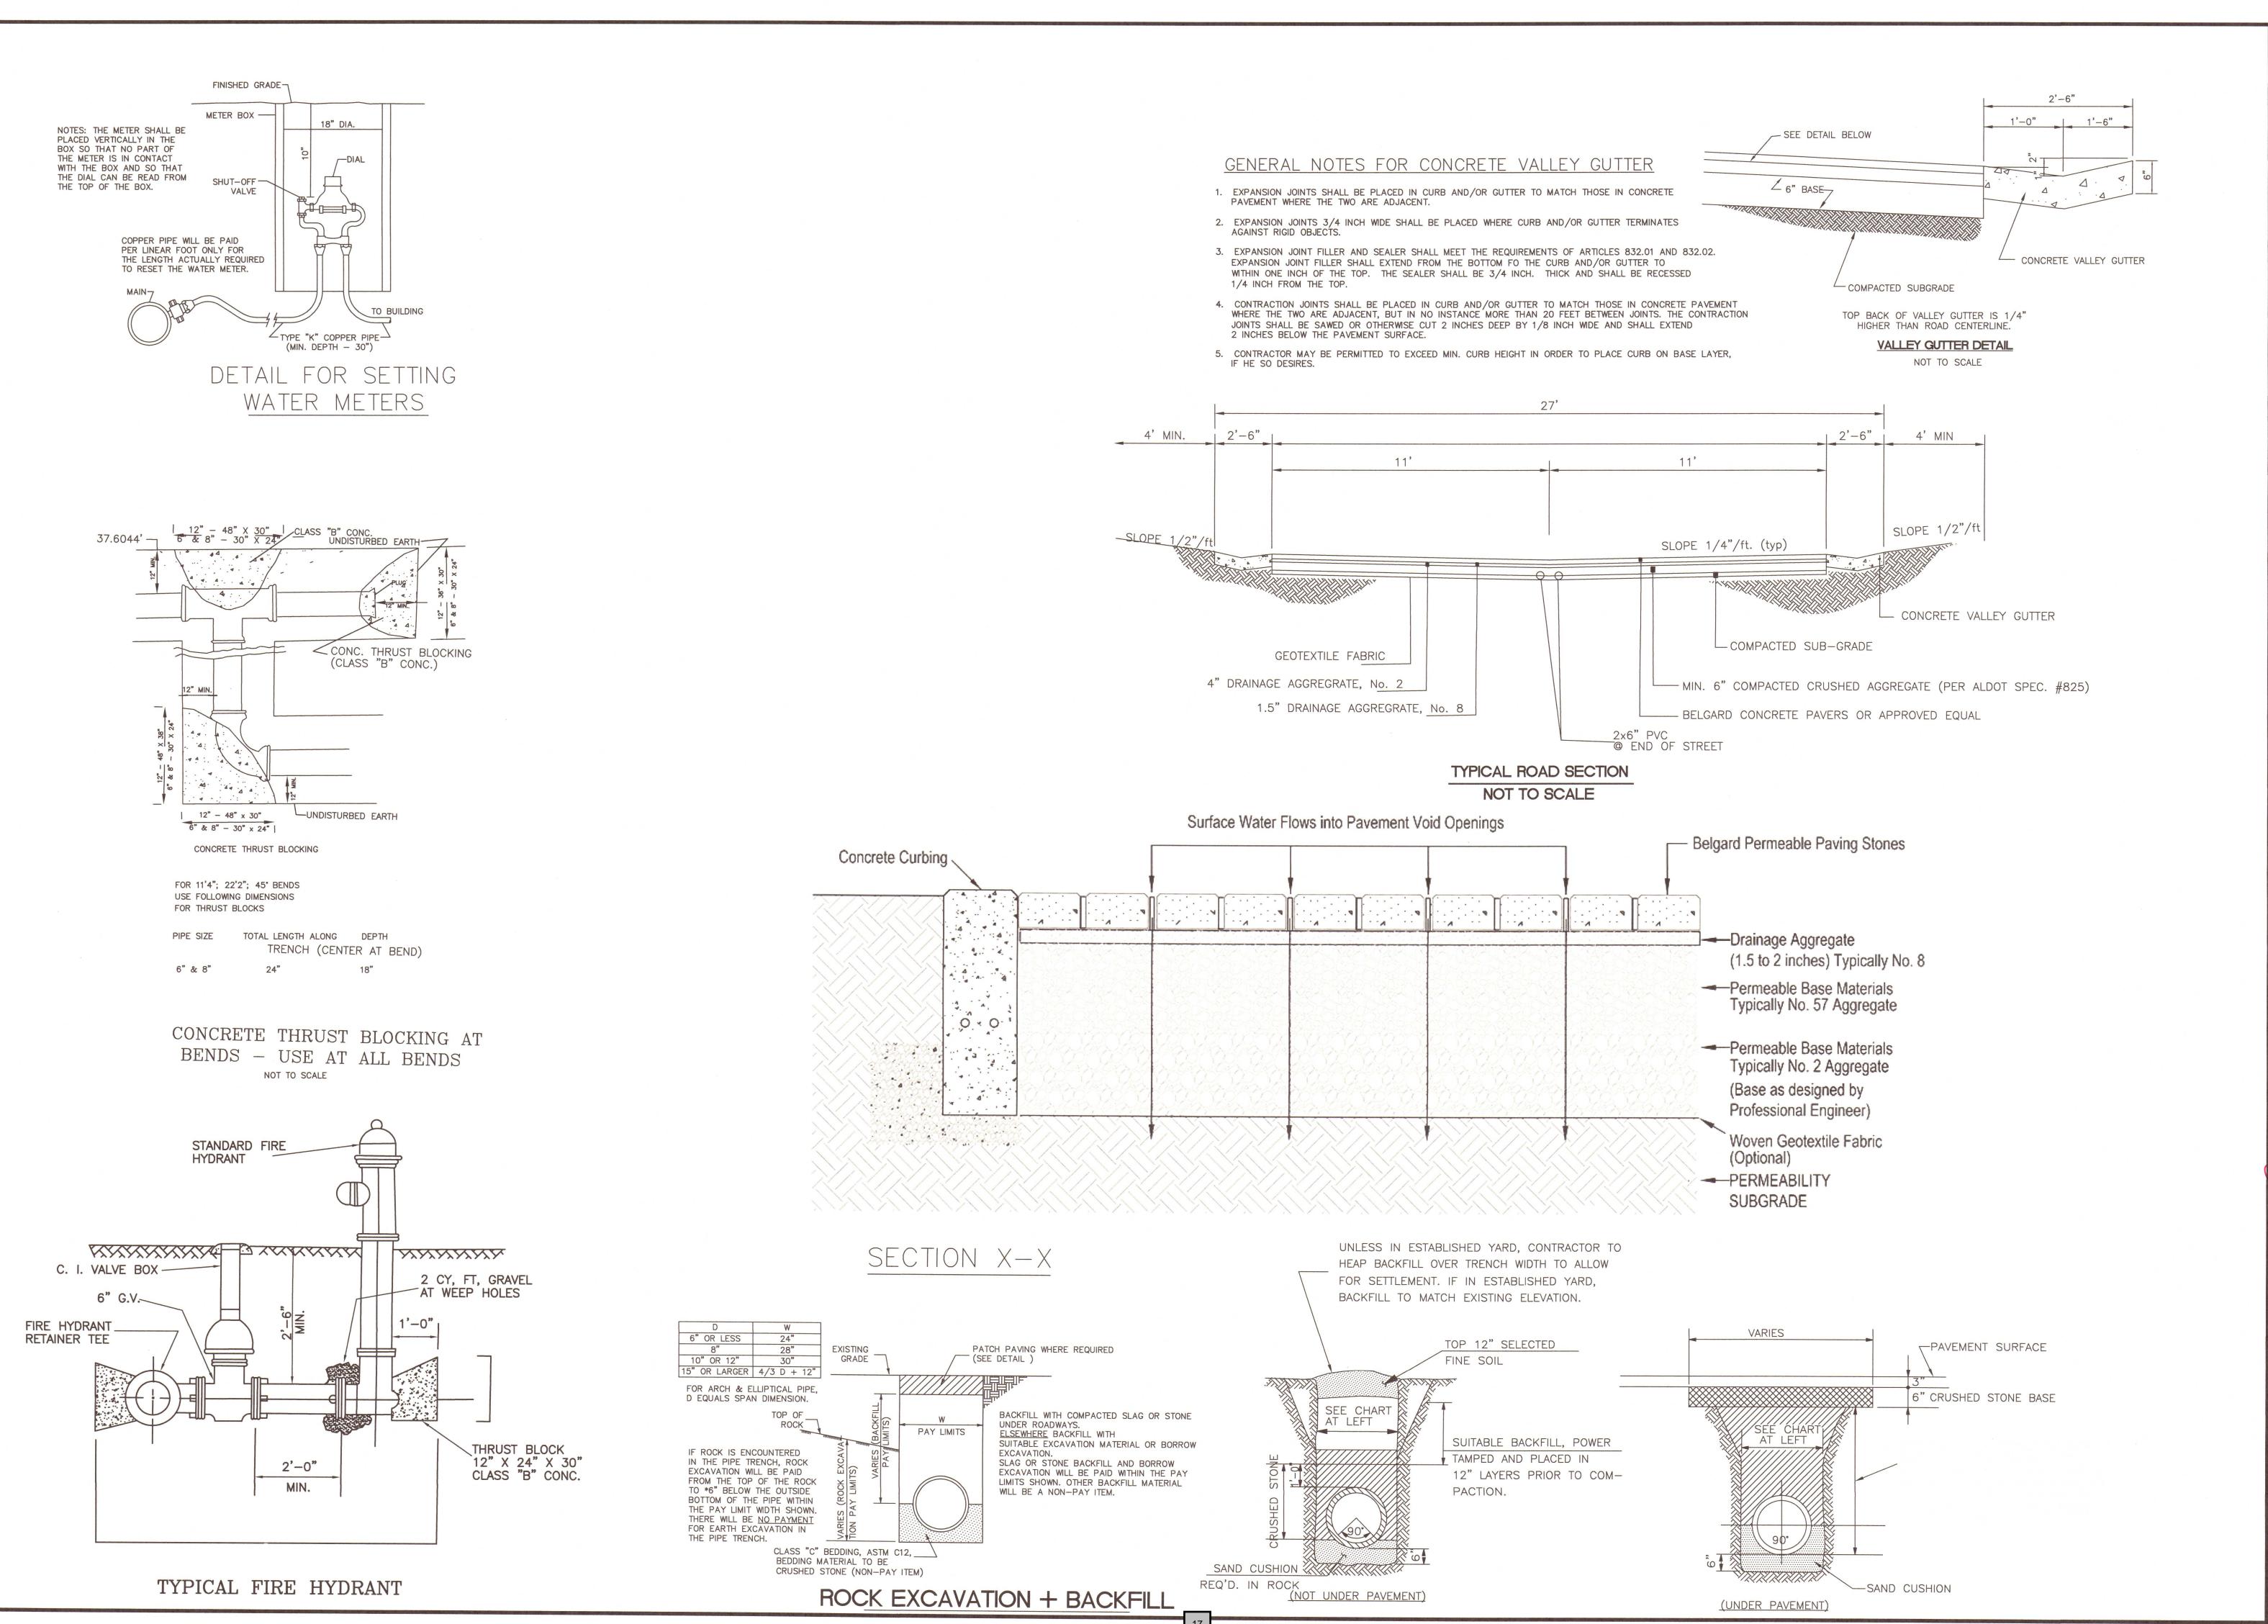
V 国 C 1 COLL

FILE NAME: I/SUBDIVISION LANE DRIVE

JAN. 9,2019 DRAWN: CHECKED: JAM III

SCALE: 1"=50' SHEET



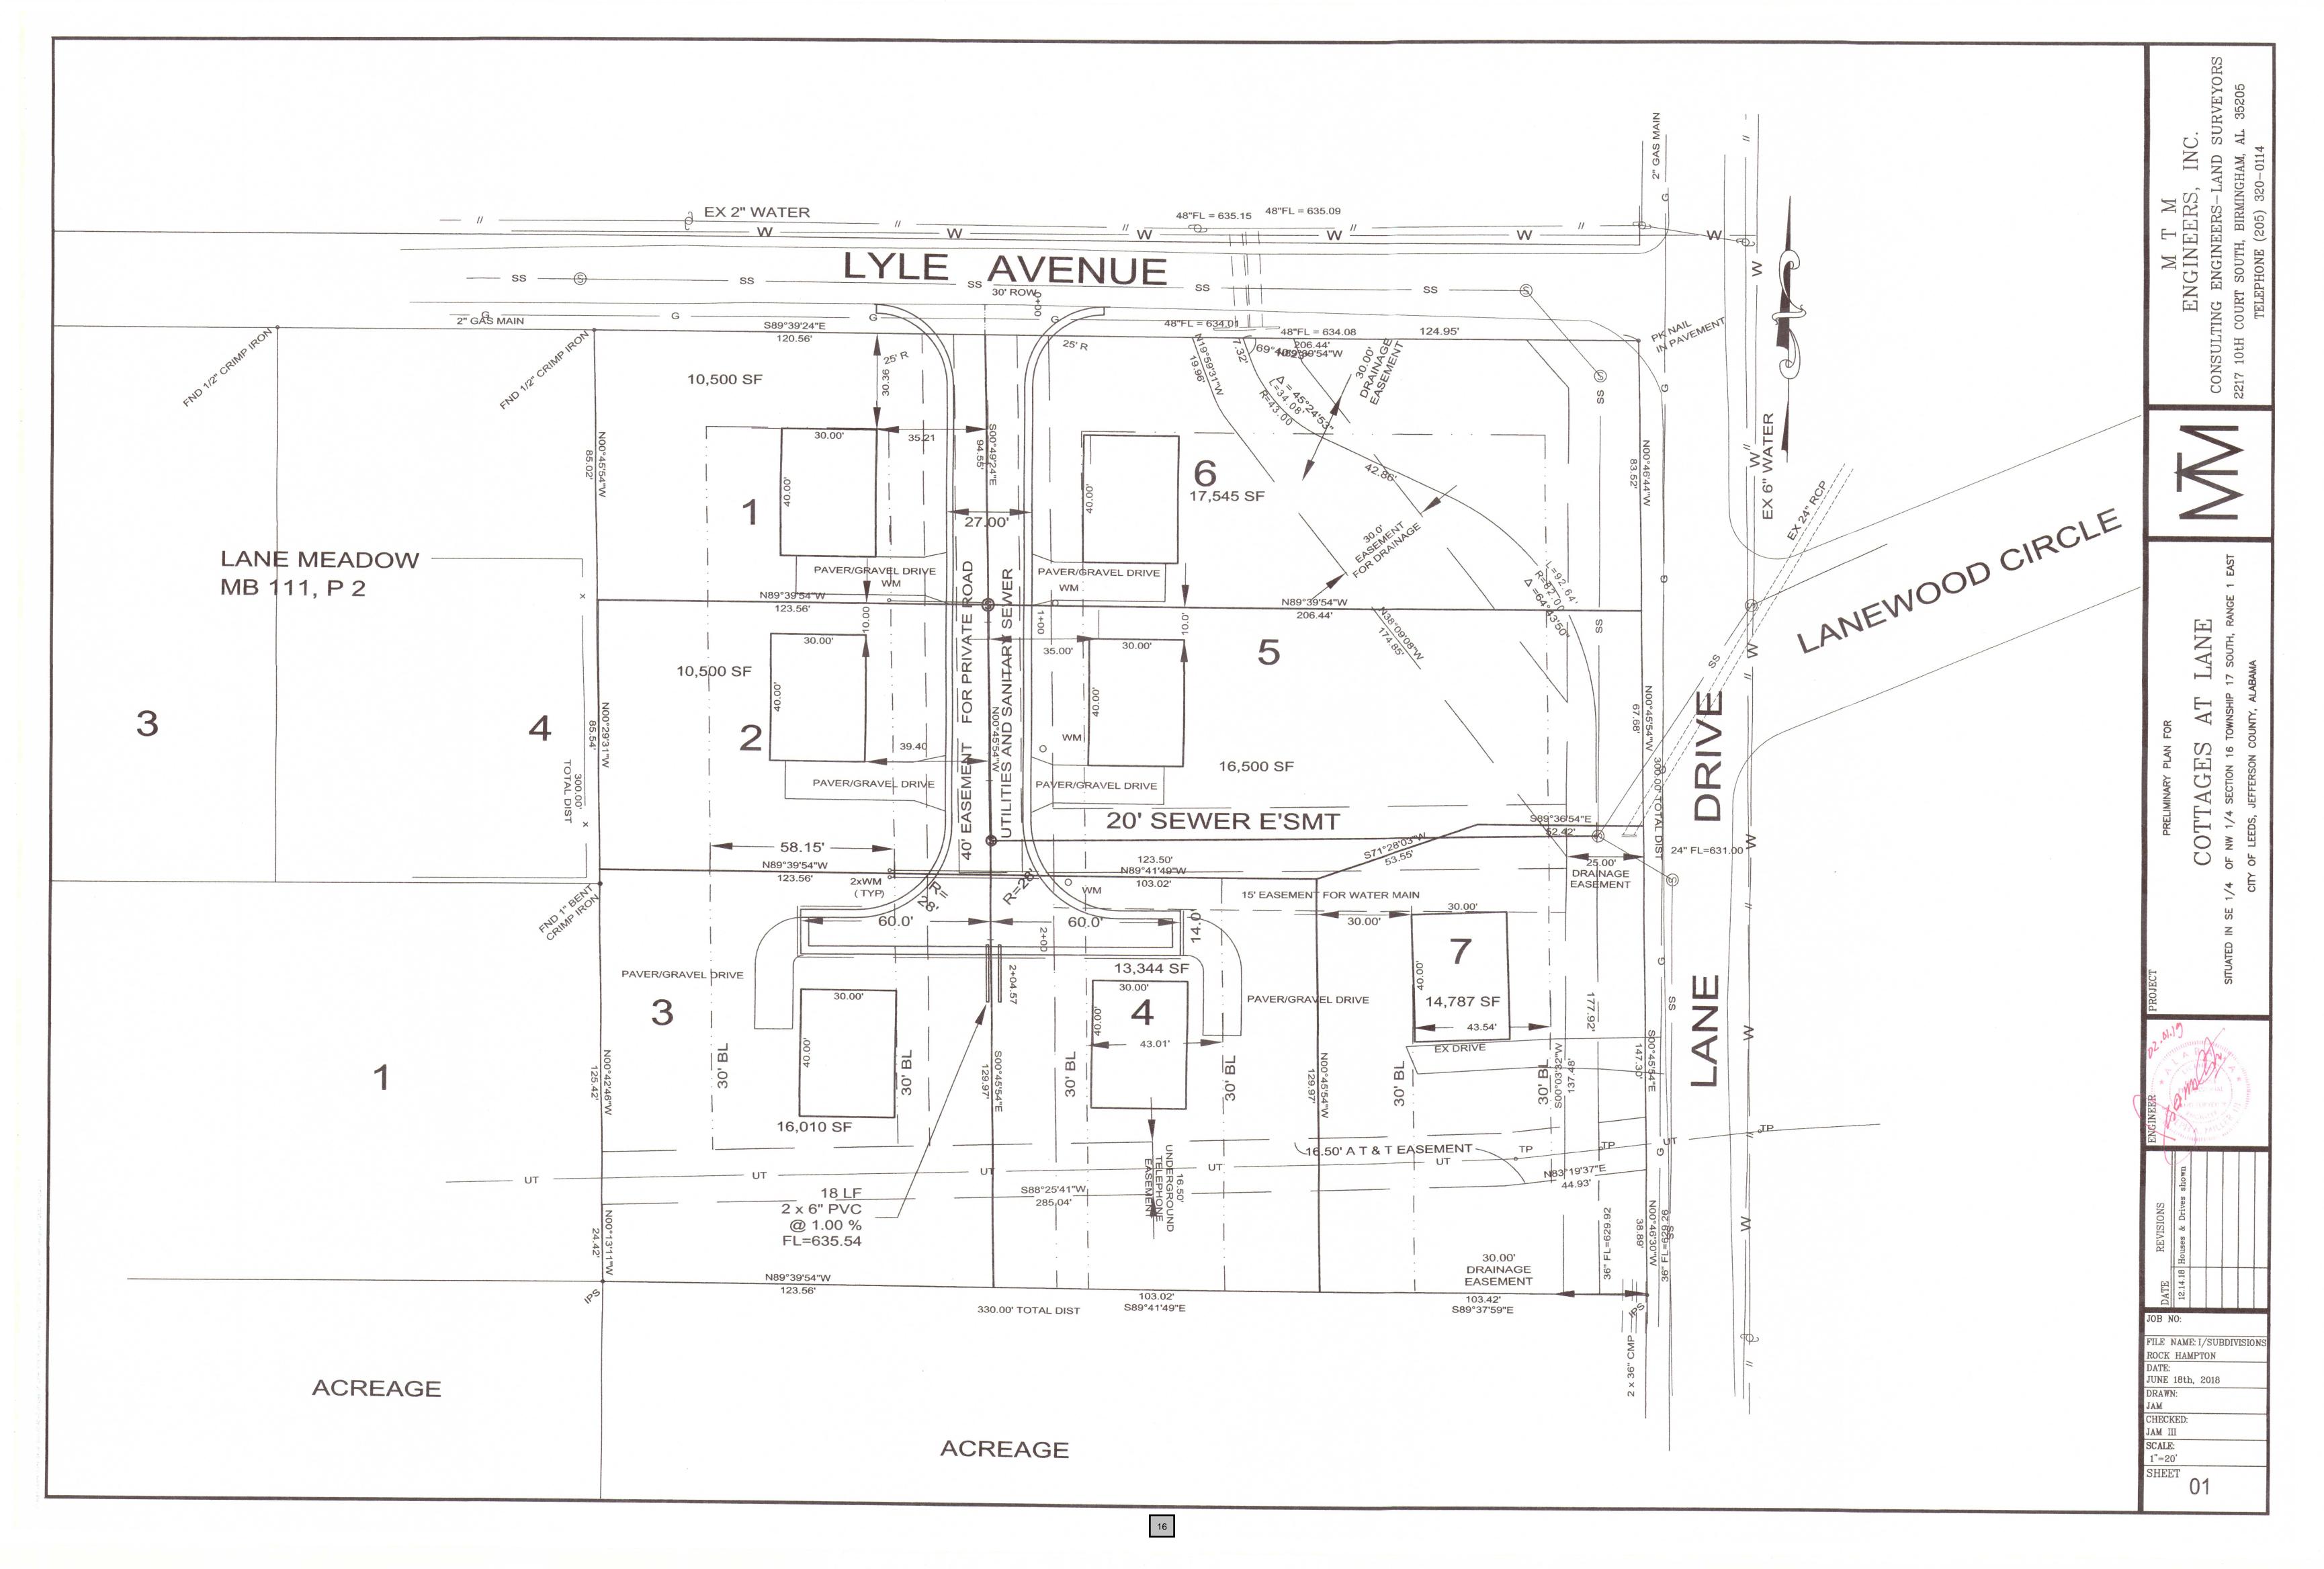

SURVEYORS AL 35205 M T M ENGINEERS,

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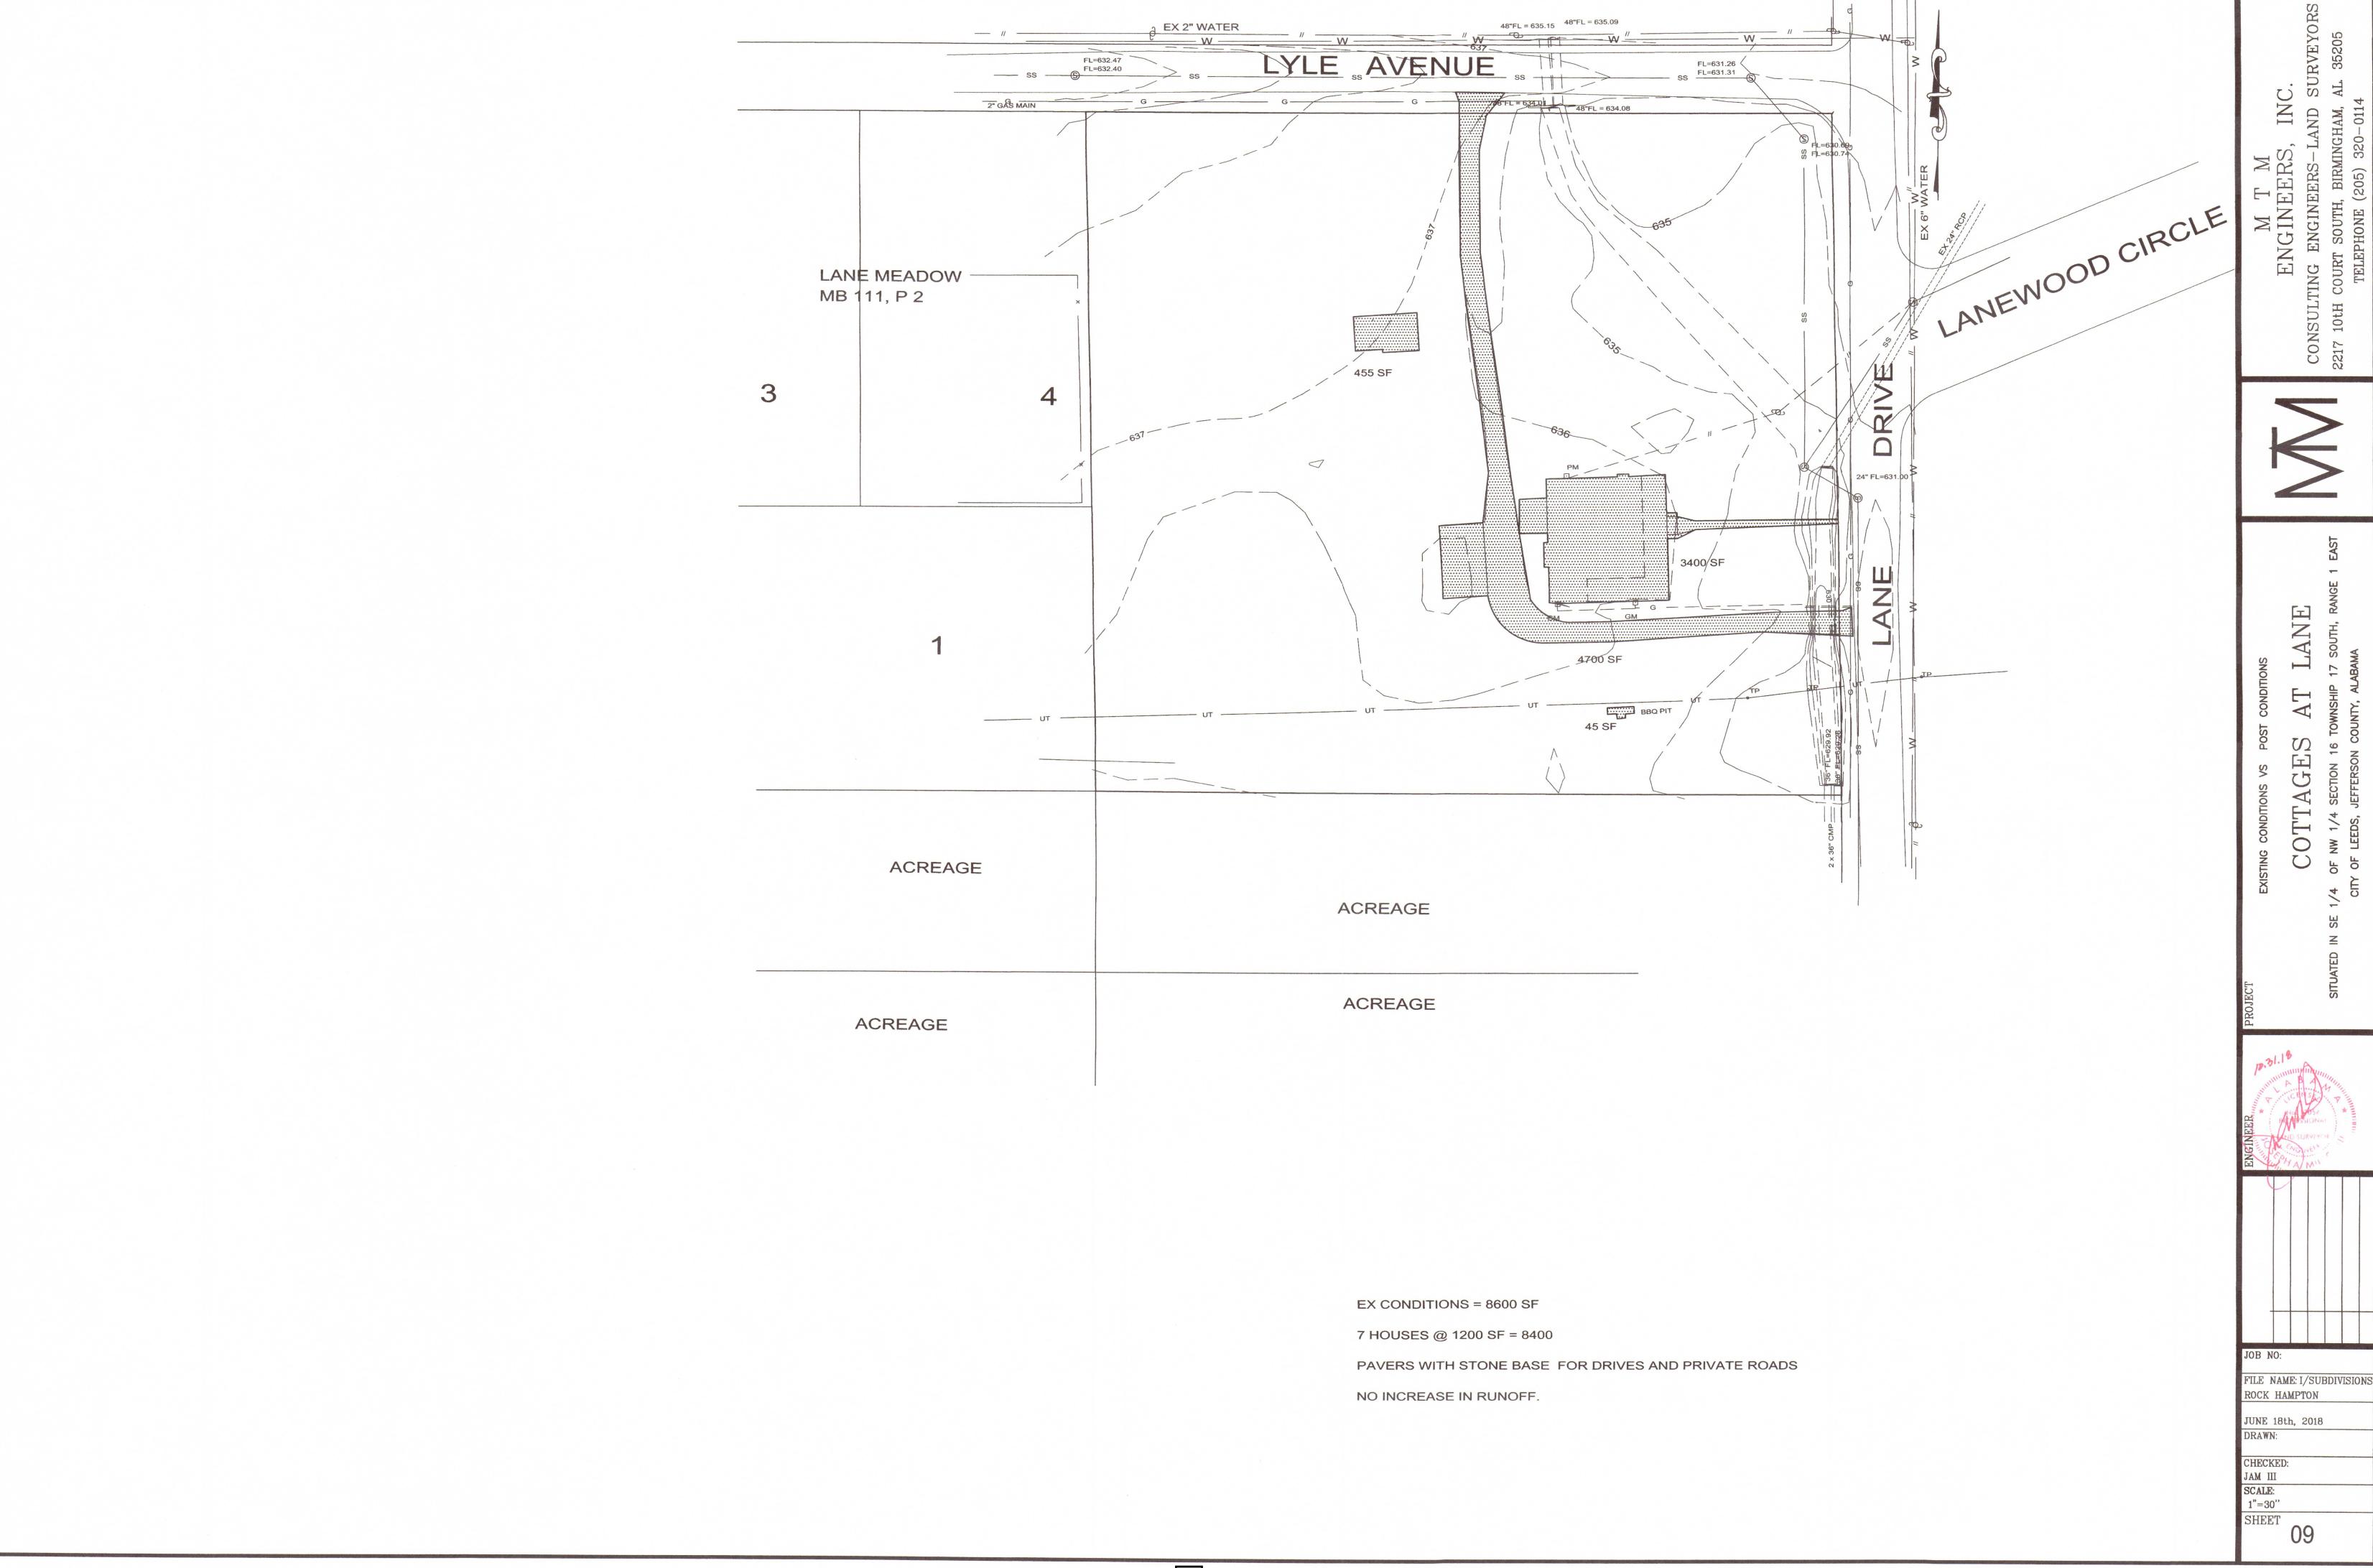
JOB NO: FILE NAME: I/SUBDIVISION:

LANE DRIVE DATE:

DRAWN: CHECKED: JAM III SCALE: NTS

Jan. 9th, 2019


SHEET



FILE NAME: I/SUBDIVISIONS LANE DRIVE JUNE 18th, 2018 DRAWN: CHECKED:

SCALE: NTS

SHEET

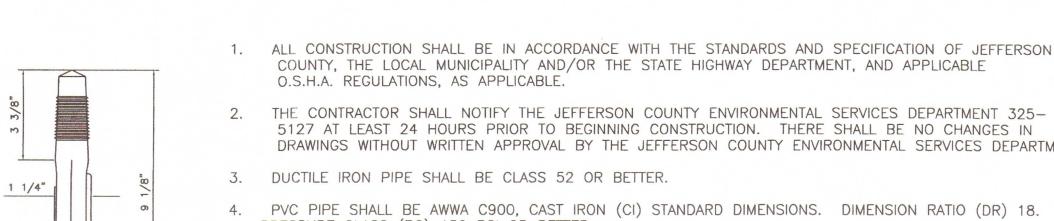

- 5127 AT LEAST 24 HOURS PRIOR TO BEGINNING CONSTRUCTION. THERE SHALL BE NO CHANGES IN DRAWINGS WITHOUT WRITTEN APPROVAL BY THE JEFFERSON COUNTY ENVIRONMENTAL SERVICES DEPARTMENT.
- PRESSURE CLASS (PC) 150 PSI OR BETTER.
- IN EARTH TRENCH, FOUR INCHES OF CRUSHED STONE SHALL BE PLACED UNDER SEWER LINES OF 12 INCHES IN DIAMETER OR SMALLER AND SIX INCHES OF CRUSHED STONE SHALL BE PLACED UNDER SEWER LINES LARGER THAN 12 INCHES IN DIAMETER. IN ROCK TRENCHES, SIX INCHES OF CRUSHED STONE SHALL BE PLACED UNDER ALL SEWERS. THE DITCH SHALL BE BACKFILLED WITH CRUSHED STONE TO A DEPTH OF 12 INCHES ABOVE THE TOP OF THE PIPE. WHEN CROSSING EXISTING ROADS, STREETS, AND ALL PAVEMENT IN AND OUT OF THE R.O.W., THE TOTAL BACKFILL SHALL BE CRUSED STONE AND PROPERLY CHOKED.
- AT THE DIRECTION OF THE ESD INSPECTOR, A CONNECTION OF SANITARY SEWER PIPES (8 INCH THROUGH 16 INCH) OF DISSIMILAR SIZES OR FOR REPAIR OF SANITARY SEWER PIPES OF SIMILAR MATERIALS MAY BE MADE BY MEANS OF AN APPROVED MECHANICAL SEAL TYPE ADJUSTABLE COUPLING. COUPLINGS WITH ANY REQUIRED ADAPTING BUSHINGS SHALL BE MANUFACTURED OF AN APPROVED PREFORMED ELASTOMERIC MATERIAL SPECIFICALLY FOR DIMENSIONS OF THE PIPE MATERIALS TO BE CONNECTED. COUPLINGS OF THE MECHANICAL SEAL TYPE SHALL HAVE NUT AND BOLT TIGHTENING CLAMPS OR DEVICES MADE OF 316 STAINLESS STEEL, WITH AN ADJUSTABLE STAINLESS STEEL SHEAR RING, AND STAINLESS STEEL HARDWARE. A CONCRETE COLLAR AS SHOWN ON APPENDIX STANDARD DRAWING SD2060 IS REQUIRED. THE ADJUSTABLE COUPLING SHALL BE INSTALLED AS RECOMMENDED AND SPECIFIED BY THE MANUFACTURER. EACH COUPLING SHALL BEAR THE MANUFACTURER'S NAME AND REQUIRED MARKINGS.
- MANHOLES SHALL MEET ASTM SPECIFICATION C-478. JOINTS BETWEEN THE MANHOLE SECTIONS SHALL BE OFFSET TONGUE AND GROOVE "PUSH ON" TYPE, SUPPLIED WITH TYLOX SUPER SEAL PRE-LUBRICATED GASKET AS MANUFACTURED BY HAMILTON KENT MEETING THE REQUIREMENTS OF ASTM C443. EACH JOINT SHALL ALSO BE SUPPLIED WITH CONSEAL CS-231 WATERSTOP SEALANT AS MANUFACTURED BY CONCRETE SEALANTS, IN WIDTHS AS RECOMMENDED BY THE MANUFACTURER. MANHOLES SHALL HAVE A MINIMUM DIAMETER OF 48 INCHES AND A MINIMUM THICKNESS OF 5 INCHES. ALL MANHOLE CONES SHALL BE OF THE CONCENTRIC TYPE. MANHOLES MAY BE FINISHED TO STREET GRADE WITH BRICK AND MORTAR. THIS ADJUSTMENT HEIGHT SHALL NOT EXCEED 16 INCHES.
- 8. STUBOUTS FOR SANITARY SEWER SERVICE LINES SHALL END ON OR NEAR THE PROPERTY LINE UNLESS OTHERWISE NOTED. ON "DOWNHILL" SIDE LOTS INSTALL LATERALS ON A MINIMUM 1% GRADE. ON "UPHILL" SIDE LOTS, INSTALL SERVICE LINES TO GRADE THAT WILL TERMINATE A MAXIMUM DEPTH OF 10 FEET. THE FIRST JOINT OUT OF A MANHOLE, FOR BUILDING OR HOUSE SERVICE, SHALL BE DUCTILE IRON PIPE CLASS 52 OR BETTER (MINIMUM 8 FEET). ANY BUILDING SERVICE LINE SET OUTSIDE OF EASEMENT OR R.O.W. MUST BE INSTALLED BY A MASTER PLUMBER AND HAVE A SEWER CONNECTION PERMIT FOR EACH LOT.
- 9. IF THE CONTRACTOR IS INSTALLING SERVICE LINES AT THE SAME TIME AS MAIN LINE, THE SERVICE LINE SHALL BE INSTALLED IN ACCORDANCE WITH JEFFERSON COUNTY STANDARDS FOR CONSTRUCTION OF SERVICE LINES AND CONNECTIONS, AND INSPECTED/TESTED BY COUNTY INSPECTOR BEFORE IT IS BACKFILLED.
- 10. ALL SERVICE LINE STUBOUTS INSTALLED IN ROAD ROW OR UNDER ASPHALT SHALL BE PER STANDARD SPECIFICATIONS FOR SANITARY SEWER SERVICE LINES AND CONNECTIONS SECTION 4.
- 11. CONSTRUCTION SIGNS FOR WORK WITHIN AND ADJACENT TO PUBLIC ROADS, HIGHWAYS, AND ALLEYS SHALL BE IN ACCORDANCE WITH ALDOT STANDARDS.
- CONTRACTOR WILL BE RESPONSIBLE FOR THE CONTINUOUS AND PROPER OPERATION OF ALL EXISTING UTILITIES LOCATED ON OR ADJACENT TO THE PROJECT SITE AND WITHIN THE CONSTRUCTION LIMITS OF THIS PROJECT.
- 13. ALL EMBANKMENT FILL AREAS SHALL BE FILLED AND COMPACTED PRIOR TO EXCAVATION OF SEWER
- LINE TRENCHES. 14. CONTRACTOR WILL BE RESPONSIBLE FOR THE CONSTRUCTION AND MAINTENANCE OF EROSION AND
- SEDIMENTATION CONTROLS AND FOR ACQUISITION OF ALL PERMITS DURING CONSTRUCTION TO INSURE THAT DAMAGE DOES NOT OCCUR TO ADJACENT PROPERTIES, PUBLIC ROADS AND/OR DITCHES (CREEKS, STREAMS)
- 15. UPON COMPLETION OF ALL OR ANY PART OF A SANITARY SEWER LINE, THE CONTRACTOR WILL BE REQUIRED TO TEST SAID SEWER FOR ACCEPTABILITY. GRAVITY SEWERS WILL BE PRESSURE TESTED WITH AIR. FORCE MAIN SEWERS WILL BE PRESSURE TESTED WITH WATER. MANHOLES WILL BE VACUUM TESTED. ALL TESTS WILL BE CONDUCTED IN THE PRESENCE OF THE COUNTY SEWER CONSTRUCTION INSPECTOR IN ACCORDANCE WITH SECTION 5.00 STANDARDS FOR COMMERCIAL AND RESIDENTIAL CONSTRUCTION OF SANITARY SEWER SYSTEMS. GRAVITY SANITARY SEWERS WILL BE TELEVISION INSPECTED FOLLOWING AIR TESTING WITH THE FINAL VIDEO TAPE AND LOG FURNISHED TO THE COUNTY FOR RECORD INFORMATION.

1 1/2 D


Pipe (Any

Class "B"

Concrete

TYPICAL CONCRETE COLLAR PIPE SIZES 12" OR LESS

Mission Adjustable Repair Coupling or Equal with Stainless Steel Bends and Stainless Steel Shear Ring

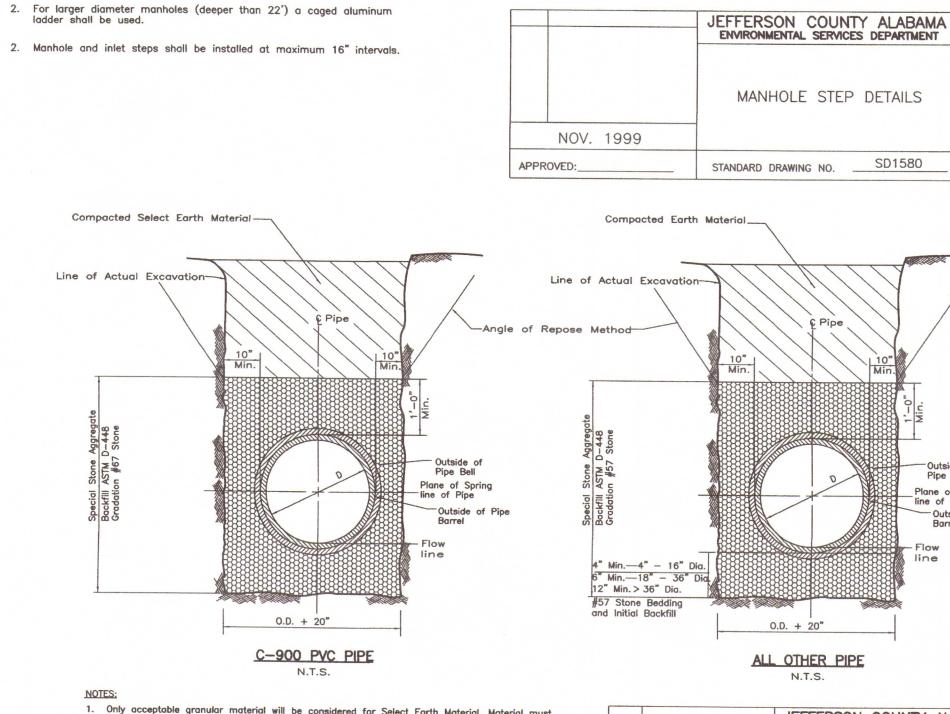


5 3/4"


Manhole and inlet steps shall be plastic coated reinforced steel.

Plastic coated manhole steps shall be polypropylene coated steel
reinforcing rods with rod and pull out ratings meeting OSHA standards

1 1/8"

10 3/4"

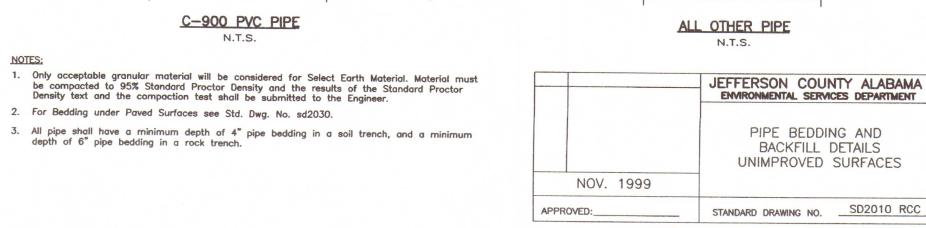

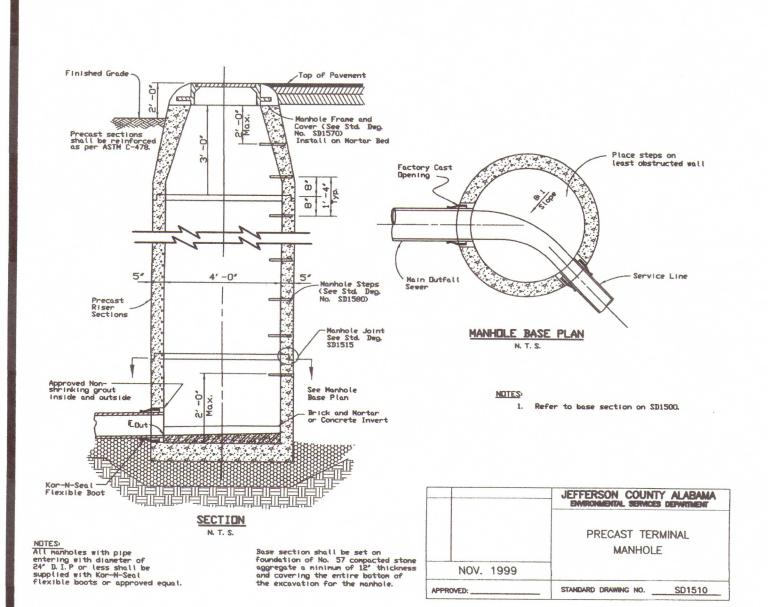

— Base section shall be set on foundation of No. 57 compacted stone aggregate a minimum of 12" thickness and covering the entire bottom of

BOLT HOLES

▼ MACHINED BEARING SURFACE

STANDARD MANHOLE

JEFFERSON COUNTY ALABAMA EMPROPARIAL SERVICES DEPARTMENT

PRECAST MANHOLE

STANDARD DRAWING NO. SD1500

FOR PIPES 18" DIAMETER

FRAME & COVER DETAILS

1 1/2"

NOTE:
No reversible frames 2'-1 3/16"

MANHOLE BASE PLAN

NOV. 1999

2 15/16"

(2) TYPE TWO NON-PENETRATING PICKHOLES

PICKHOLE DETAIL

-(4) 5/8" x 2"


COVER BACK

COVER TO


174 LBS. 124 LBS.


ESTIMATED WEIGHTS

Where the difference in the invert elevation is >6" a standard length of Ductile Iron Pipe shall be installed to bridge the fill area between the manhole and the undisturbed pipe trench.

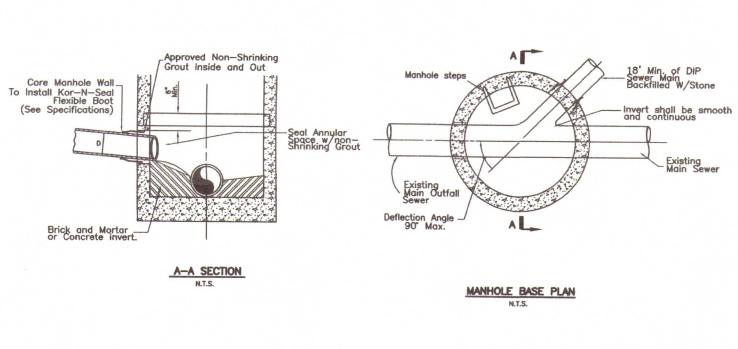


If Inverts of the influent and effluent sewer pipes exceed 2 Ft. of difference, a Memphis Tee manhole must be constructed in accordance with Drawing No. S01560.

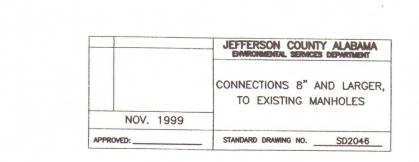

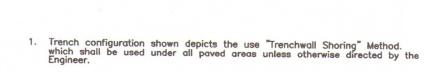



The contractor shall refer to applicable "O.S.H.A. Regulations for "Open Trench Excavations".

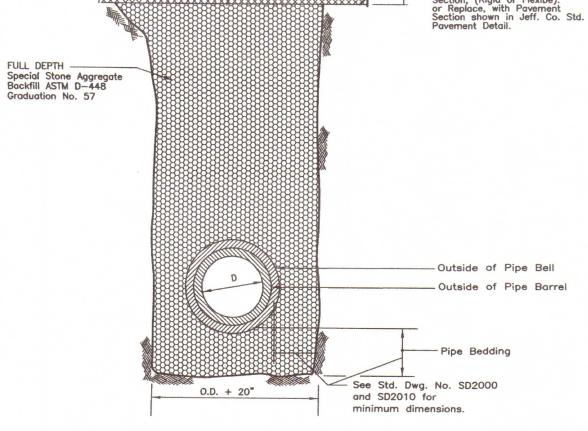


Lower Limit Of

Improved Surface

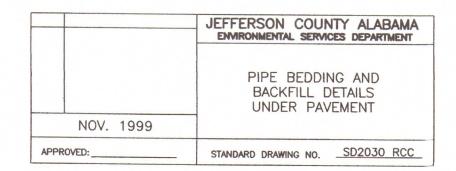

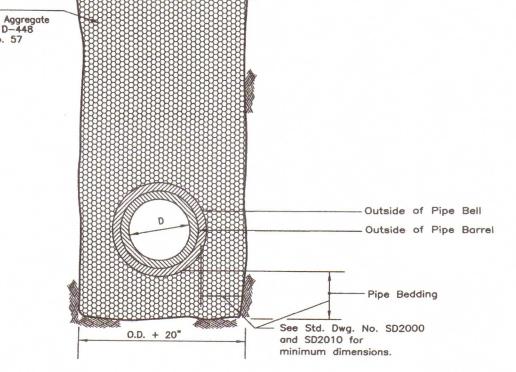

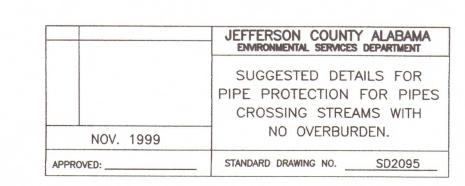

Top of Rock & F of Creek

